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DMS PARKING IMPROVEMENTS

12701 SOUTHFIELD ROAD CITY OF DETROIT, WAYNE COUNTY, MICHIGAN

SITE DATA TABLE:

SITE AREA: 39.32 ACRES (1,712,803 SQ.FT.) NET AND GROSS

ZONING: M4 - INTENSIVE INDUSTRIAL/M2 - RESTRICTED INDUSTRIAL PD - PLANNED DEVELOPMENT

PROPOSED USE: EMPLOYEE PARKING FOR EXISTING INDUSTRIAL USE

NO MINIMUM SETBACKS ARE REQUIRED IN THE M2 AND M4 ZONING DISTRICTS. PD ZONING DISTRICT - DIMENSIONAL AND INTENSITY STANDARDS FOR SETBACKS SHOULD BE APPROPRIATE TO THE NATURE OF THE DEVELOPMENT AND RELATE WELL TO THE SURROUNDING DEVELOPMENT.

PROPOSED LANDSCAPING AND PARKING, WHICH IS SETBACK TEN (10) FEET TO THE NORTH PROPERTY LINE WITHIN THE PD ZONING DISTRICT.

PARKING ADDITION:
DMS NORTH PARKING LOT EXPANSION:

98 ANGLED EMPLOYEE PARKING SPACES PER CITY STANDARDS

SITE SOILS INFORMATION:
ACCORDING TO THE USDA NATURAL RESOURCES CONSERVATION SERVICE WEB SOIL SURVEY FOR WAYNE COUNTY, THE SITE CONSISTS OF THE FOLLOWING SOIL TYPES:

UrbaqB - URBAN LAND - RIVERFRONT COMPLEX, 0 TO 4% SLOPES


LEGAL DESCRIPTION:

THAT PART OF THE NORTHEAST 1/4 OF SECTION 26, TOWN 01 SOUTH, RANGE 10 EAST, CITY OF DETROIT, WAYNE COUNTY, MICHIGAN, DESCRIBED AS FOLLOWS: COMMENCING AT THE SOUTHEAST CORNER OF LOT 28 OF "SUNNYBROOK GARDENS SUBDIVISIONS NO. 1", ACCORDING TO THE PLAT THEREOF RECORDED IN LIBER 36 OF PLATS, PAGE 35, WAYNE COUNTY RECORDS; THENCE SOUTH 89 DEGREES 37 MINUTES 27 SECONDS WEST, 16.89 RIGHT-OF-WAY LINE OF SOUTHFIELD FREEWAY (M-39) AND THE POINT OF BEGINNING FOR THIS PARCEL THENCE SOUTH 02 DEGREES 11 MINUTES 10 SECONDS WEST, ALONG THE SAID WESTERLY RIGHT-OF-WAY ALONG A CURVE TO THE RIGHT, WITH A RADIUS 359.44 FEET, ARC OF 16.48 FEET, CHORD BEARING SOUTH 37 DEGREES 11 MINUTES 32 SECONDS WEST, 16.47 FEET TO A POINT ON THE NORTH RIGHT-OF-WAY LINE OF THE RAILROAD: THENCE SOUTH 89 DEGREES 36 MINUTES 48 SECONDS WEST, ALONG SAID NORTH RIGHT-OF-WAY LINE, 2373.96 FEET TO A POINT ON THE EAST RIGHT-OF-WAY LINE OF ARTESIAN AVENUE; THENCE NORTH 00 DEGREES 37 MINUTES 51 SECONDS WEST, ALONG SAID EAST RIGHT-OF-WAY LINE, 1263.12 FEET TO THE SOUTHWEST CORNER OF LOT 79 OF "B.E. TAYLOR'S STRATHMOORE-COLONIAL SUBDIVISION" AS RECORDED II LIBER 50 OF PLATS, PAGE 81, WAYNE COUNTY RECORDS: THENCE NORTH 89 DEGREES 37 MINUTES 47 SECONDS EAST, ALONG THE SOUTH LINE OF SAID "B.E. TAYLOR'S STRATHMOORE-COLONIAL SUBDIVISION", 1278.75 FEET TO THE SOUTHEAST CORNER OF "B.E. TAYLOR'S STRATHMOORE-COLONIAL SUBDIVISION" AND THE SOUTHWEST CORNER OF "SUNNYBROOK GARDENS SUBDIVISIONS NO. 1"; THENCE NORTH 89 DEGREES 37 MINUTES 27 SECONDS EAST, ALONG THE SOUTH LINE OF SAID "SUNNYBROOK GARDENS SUBDIVISIONS NO. 1". 1128.41 FEET RETURNING TO THE POINT OF BEGINNING FOR THIS PARCEL.

PROJECT DESCRIPTION:

PARCEL NO.: 22074253-5

ADDITION OF 98 EMPLOYEE PARKING SPACES ON THE NORTH SIDE OF THE EXISTING PARKING LOT TO CAPTURE THE GROWING WORK FORCE OF THE DETROIT MANUFACTURING SYSTEMS FACILITY.

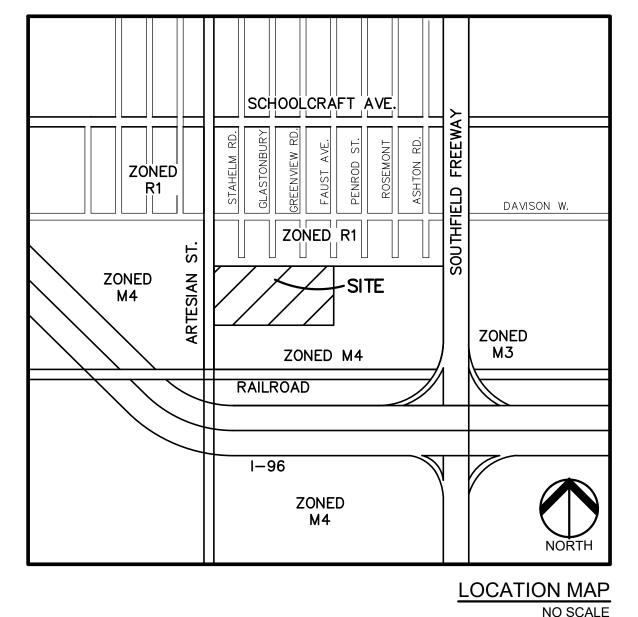

COVER SHEET TOPOGRAPHIC SURVEY C-2.0 DEMOLITION PLAN OVERALL SITE PLAN **DIMENSION AND PAVING PLAN - 1** DIMENSION AND PAVING PLAN - 2 PRELIMINARY GRADING PLAN - 1 PRELIMINARY GRADING PLAN - 2 PRELIMINARY UTILITY PLAN NOTES AND DETAILS LANDSCAPE PLAN LANDSCAPE DETAILS

NUMBER TITLE

INDEX OF DRAWINGS

ALTERNATIVE ENGINEERED DESIGN

DESIGN TEAM

OWNER/APPLICANT

INNOVO DEVELOPMENT GROUP 1321 W. WESTNEDGE AVE. KALAMAZOO, MI 49008 CONTACT: TRAE ALLMAN, PRINCIPAL PHONE: 269.830.9124 EMAIL: TRAE@INNOVODEV.COM

ARCHITECT LANDSCAPE ARCHITECT

DRIVEN DESIGN GROUP 4162 ENGLISH OAK DRIVE LANSING, MICHIGAN 48911 CONTACT: CHRIS MILLER, PE, CEM PHONE: 989.573.0710

PEA GROUP 45 W. GRAND RIVER AVE., STE. 501 DETROIT, MI 48226 CONTACT: NOAH BIRMELIN, PLA, ASLA PHONE: 844.813.2949 EMAIL: NBIRMELIN@PEAGROUP.COM EMAIL: CMILLER@DRIVENDG.COM

CIVIL ENGINEER

58105 VAN DYKE RD.


PHONE: 844.813.2949


WASHINGTON TWP., MI 48094

CONTACT: MICHAEL R. MOTTE, PE

EMAIL: MMOTTE@PEAGROUP.COM

PEA GROUP

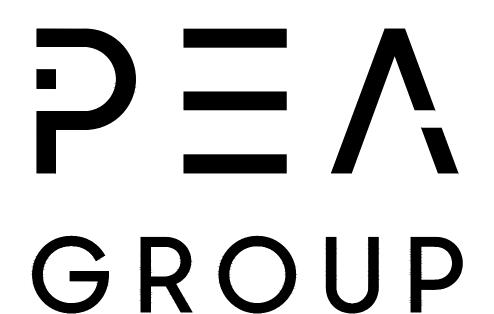

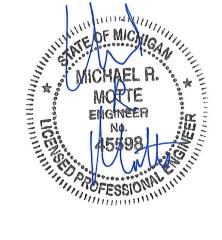

REVISIONS	
DESCRIPTION	DATE
OWNER REVIEW	9/11/2023

LEGAL DESCRIPTION:

THAT PART OF THE NORTHEAST 1/4 OF SECTION 26, TOWN 01 SOUTH, RANGE 10 EAST, CITY OF DETROIT, WAYNE COUNTY, MICHIGAN, DESCRIBED AS FOLLOWS: COMMENCING AT THE SOUTHEAST CORNER OF LOT 28 OF "SUNNYBROOK GARDENS SUBDIVISIONS NO. 1", ACCORDING TO THE PLAT THEREOF RECORDED IN LIBER 36 OF PLATS, PAGE 35, WAYNE COUNTY RECORDS; THENCE SOUTH 89 DEGREES 37 MINUTES 27 SECONDS WEST, 16.89 FEET ALONG THE SOUTH LINE OF "SUNNYBROOK GARDENS SUBDIVISIONS NO. 1" TO A POINT ON THE WESTERLY RIGHT-OF-WAY LINE OF SOUTHFIELD FREEWAY (M-39) AND THE POINT OF BEGINNING FOR THIS PARCEL; THENCE SOUTH 02 DEGREES 11 MINUTES 10 SECONDS WEST, ALONG THE SAID WESTERLY RIGHT-OF-WAY, 649.62 FEET; THENCE CONTINUING ALONG THE SAID WESTERLY RIGHT-OF-WAY ALONG A CURVE TO THE LEFT, WITH A RADIUS 1936.86 FEET, ARC OF 139.98 FEET, CHORD BEARING SOUTH 00 DEGREES 06 MINUTES 57 SECONDS WEST, 139.95; THENCE SOUTH 01 DEGREES 57 MINUTES 19 SECONDS EAST, CONTINUING ALONG THE SAID WESTERLY RIGHT-OF-WAY, 460.73 FEET; THENCE CONTINUING ALONG THE SAID WESTERLY RIGHT-OF-WAY ALONG A CURVE TO THE RIGHT, WITH A RADIUS 359.44 FEET, ARC OF 16.48 FEET, CHORD BEARING SOUTH 37 DEGREES 11 MINUTES 32 SECONDS WEST, 16.47 FEET TO A POINT ON THE NORTH RIGHT-OF-WAY LINE OF THE RAILROAD; THENCE SOUTH 89 DEGREES 36 MINUTES 48 SECONDS WEST, ALONG SAID NORTH RIGHT-OF-WAY LINE, 2373.96 FEET TO A POINT ON THE EAST RIGHT-OF-WAY LINE OF ARTESIAN AVENUE; THENCE NORTH 00 DEGREES 37 MINUTES 51 SECONDS WEST, ALONG SAID EAST RIGHT-OF-WAY LINE, 1263.12 FEET TO THE SOUTHWEST CORNER OF LOT 79 OF 'B.E. TAYLOR'S STRATHMOORE-COLONIAL SUBDIVISION" AS RECORDED IN LIBER 50 OF PLATS, PAGE 81. WAYNE COUNTY RECORDS; THENCE NORTH 89 DEGREES 37 MINUTES 47 SECONDS EAST, ALONG THE SOUTH LINE OF SAID "B.E. TAYLOR'S STRATHMOORE-COLONIAL SUBDIVISION", 1278.75 FEET TO THE SOUTHEAST CORNER OF "B.E. TAYLOR'S STRATHMOORE-COLONIAL SUBDIVISION" AND THE SOUTHWEST CORNER OF "SUNNYBROOK GARDENS SUBDIVISIONS NO. 1": THENCE NORTH 89 DEGREES 37 MINUTES 27 SECONDS EAST. ALONG THE SOUTH LINE OF SAID "SUNNYBROOK GARDENS SUBDIVISIONS NO. 1", 1128.41 FEET RETURNING TO THE POINT OF BEGINNING FOR THIS PARCEL.

BENCHMARKS

(NAVD 88, GPS DERIVED)

BM 301

NORTHEAST BOLT ON NORTHEAST COLUMN OF BUILDING A. 30' NORTH OF NORTHEAST BUILDING CORNER AND 1300' EAST OF CENTER LINE OF ARTESIAN STREET. ELEVATION — 628.62

BM 35

"+" ON TOP OF LIGHT POLE CONCRETE BASE. LIGHT IS $45'\pm$ NORTHWEST OF CORNER OF THE MAIN BUILDING ON THE SUBJECT PROPERTY. ELEVATION -628.86

FLOODPLAIN:

BY GRAPHIC PLATTING, THE SUBJECT PARCEL IS IN "ZONE X" PER FEMA FLOOD INSURANCE RATE MAP NUMBER 26163C0100E, EFFECTIVE DATE OF 2/2/2012.


LEGEND: -OH-ELEC-W-O- EX. OH. ELEC, POLE & GUY WIRE -UG-CATV-TV- EX. U.G. CABLE TV & PEDESTAL -UG-ELEC-E-E-E-EX. U.G. ELEC,MANHOLE, METER & HANDHOLE — - — - — EX. GAS LINE © GAS EX. GAS VALVE & GAS LINE MARKER - — — — EX. WATER MAIN EX. SANITARY SEWER EX. COMBINED SEWER MANHOLE —— -- EX. STORM SEWER ■ ● EX. SQUARE, ROUND & BEEHIVE CATCH BASIN EX. YARD DRAIN, U.G. ROOF DRAIN & DOWNSPOUT EX. UNIDENTIFIED STRUCTURE M → ※ EX. MAILBOX, SIGN, LIGHTPOLE & GUARD POST X EX. FENCE • • • EX. GUARD RAIL EX. DEC. TREE, CONIFEROUS TREE & SHRUB EX. TREE TAG, & TREE LINE EX. SPOT ELEVATION EX. CONTOUR EX WETLAND BRASS PLUG SET MONUMENT FOUND / SET SECTION CORNER FOUND

RECORDED / MEASURED / CALCULATED

RMC






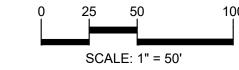




CAUTION!!
THE LOCATIONS AND ELEVATIONS OF EXISTING UNDERGROUND UTILITIES AS SHOWN ON THIS DRAWING ARE ONLY APPROXIMATE. NO GUARANTEE IS EITHER EXPRESSED OR IMPLIED AS TO THE COMPLETENESS OR ACCURACY THEREOF. THE CONTRACTOR SHALL BE EXCLUSIVELY RESPONSIBLE FOR DETERMINING THE EXACT UTILITY LOCATIONS AND ELEVATIONS PRIOR TO THE START OF CONSTRUCTION.

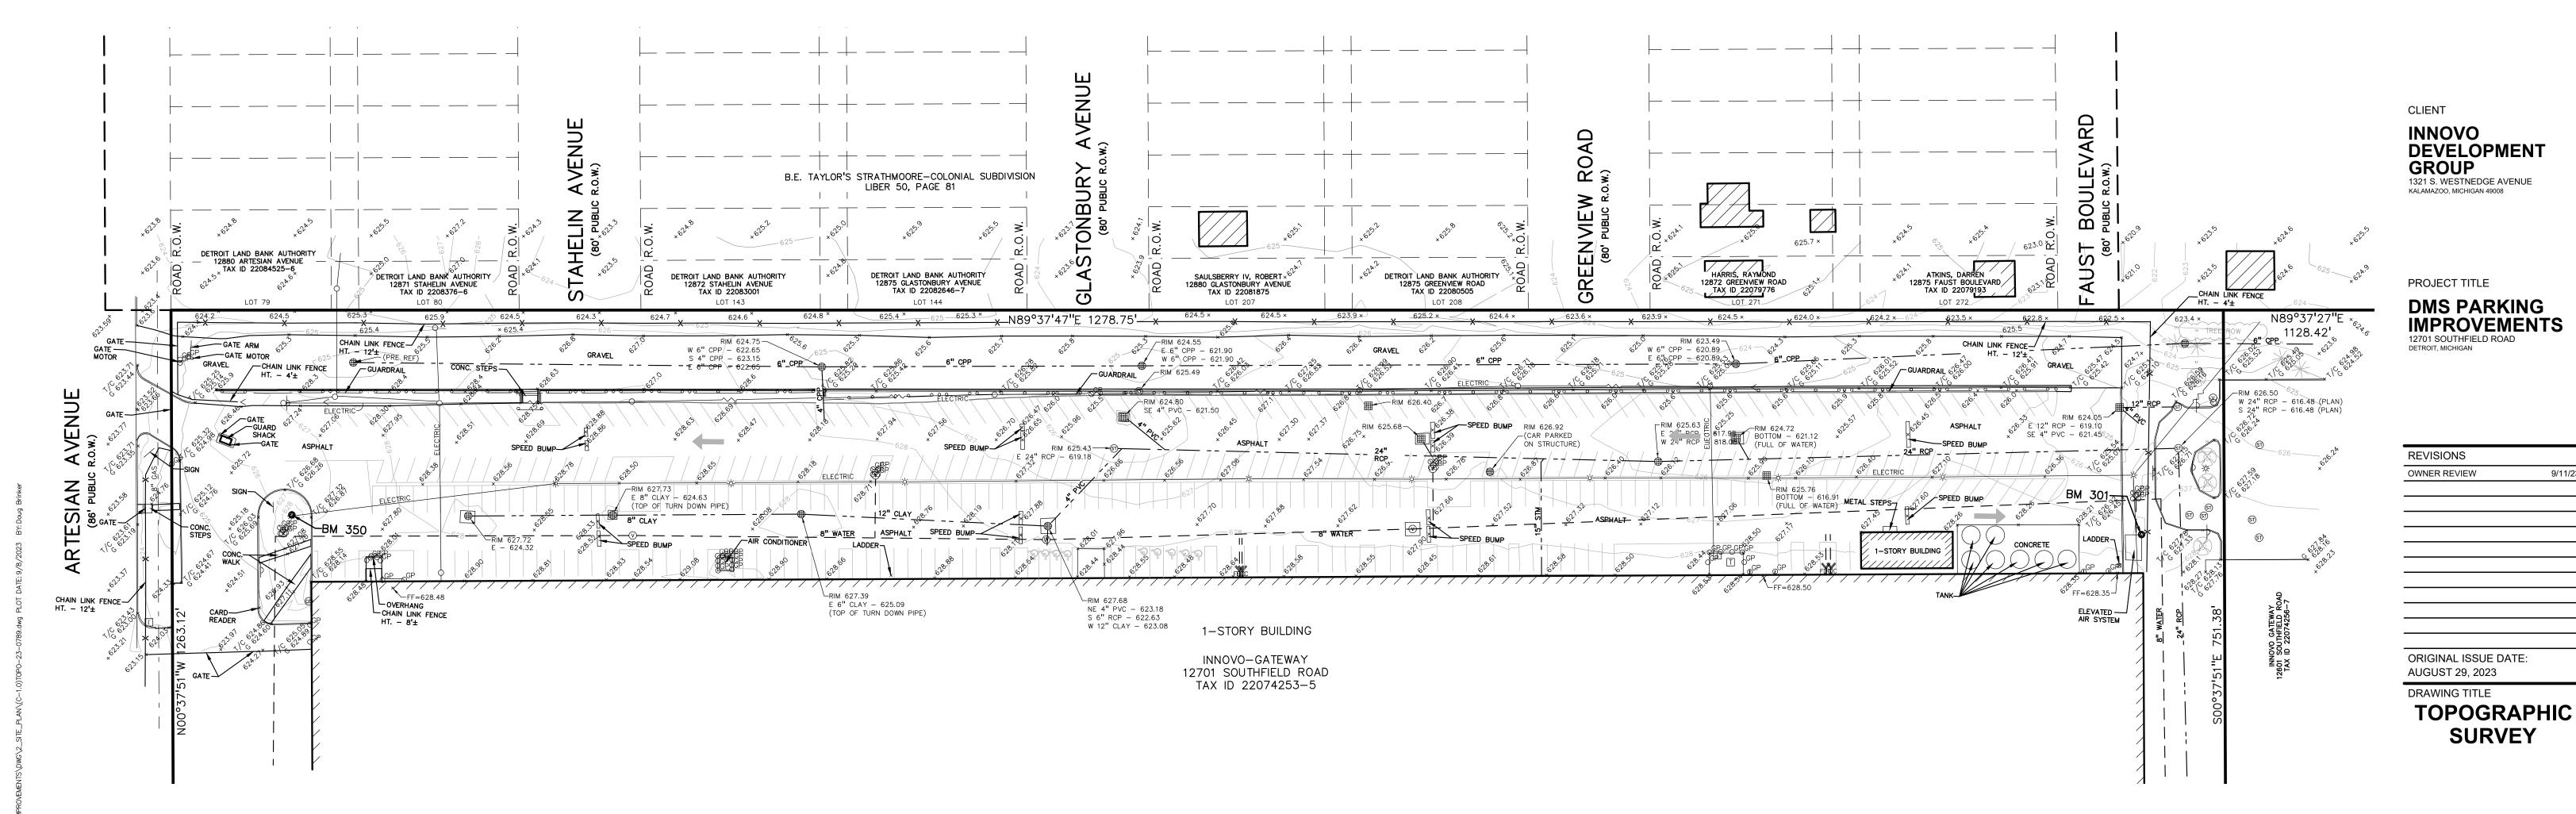

PEA JOB NO.	23-0789
P.M.	MRM
DN.	DLB
DES.	DLB
DRAWING NUMBER:	

GENERAL DEMOLITION NOTES:

- THESE NOTES APPLY TO ALL CONSTRUCTION ACTIVITIES ON THIS PROJECT:
- 1. ALL MATERIAL TO BE REMOVED, WHETHER SPECIFICALLY NOTED IN THE PLANS OR NOT, SHALL BE REMOVED FROM THE SITE BY THE CONTRACTOR AND DISPOSED OF OFF-SITE IN A LEGAL MANNER. NO ON-SITE BURY OR BURN PITS SHALL BE ALLOWED.
- 2. ALL DEMOLITION WORK SHALL CONFORM TO ALL LOCAL CODES AND
- 3. STAGING/PHASING OF DEMOLITION AND CONSTRUCTION IS TO BE COORDINATED WITH THE OWNER AND THE CONTRACTOR PRIOR TO CONSTRUCTION.
- 4. SPECIFIC DEMOLITION ITEMS HAVE BEEN INDICATED ON THE PLANS AS A GUIDE TO THE GENERAL SCOPE OF THE WORK. IT IS THE INTENT
 THAT THESE ITEMS SHALL BE COMPLETELY REMOVED BY THE
 CONTRACTOR ABOVE AND BELOW GROUND, UNLESS SPECIFICALLY NOTED OTHERWISE, AND THAT DEMOLITION WILL INCLUDE BUT WILL NOT NECESSARILY BE LIMITED TO THESE ITEMS. CONTRACTOR SHALL VISIT SITE TO VERIFY EXISTING CONDITIONS AND EXTENTS OF THE DEMOLITION THAT WILL BE REQUIRED PRIOR TO SUBMITTING A BID.
- REMOVE ALL STRUCTURES DESIGNATED FOR REMOVAL ACCORDING TO THE DEMOLITION PLAN. THIS INCLUDES FOUNDATIONS, FOOTINGS, FOUNDATION WALLS, FLOOR SLABS, UNDERGROUND UTILITIES, CONCRETE, ASPHALT, TREES, ETC.
- 6. THE CONTRACTOR SHALL, AS A MINIMUM, PROVIDE TREE PROTECTION FENCING AROUND EXISTING TREES TO BE SAVED THAT ARE WITHIN 15 FEET OF CONSTRUCTION ACTIVITIES AND AS INDICATED IN THE PLANS OR PER LOCAL AGENCY REQUIREMENTS.
- THE CONTRACTOR SHALL BE RESPONSIBLE FOR CLEAN UP, NOISE, DUST CONTROL, STREET SWEEPING AND HOURS OF OPERATION IN ACCORDANCE WITH THE LOCAL CODES.
- 8. THE CONTRACTOR SHALL PROVIDE ALL NECESSARY BARRICADES, SIGNAGE, MARKINGS, LIGHTS AND OTHER TRAFFIC CONTROL DEVICES TO PROTECT THE WORK ZONE AND SAFELY MAINTAIN TRAFFIC PER AGENCY REQUIREMENTS AND IN ACCORDANCE WITH THE LATEST EDITION OF THE STATE MANUAL OF UNIFORM TRAFFIC CONTROL DEVICES.
- 9. THE CONTRACTOR SHALL CONTACT THE APPROPRIATE UTILITY COMPANIES TO CONFIRM THAT UTILITY LEADS HAVE BEEN TAKEN OUT OF SERVICE PRIOR TO DEMOLITION.
- 10. ALL BUILDING GAS LEADS, METERS AND ASSOCIATED EQUIPMENT SHALL BE REMOVED AS SHOWN ON THE PLANS. COORDINATE ALL ASSOCIATED WORK WITH THE APPROPRIATE UTILITY COMPANY.
- I. REMOVE ALL OVERHEAD AND UNDERGROUND ELECTRICAL LINES WITHIN THE AREA OF CONSTRUCTION AS SHOWN ON THE PLANS. COORDINATE SHUTDOWNS AND REMOVALS WITH ELECTRICAL SERVICE PROVIDER OR THE APPROPRIATE UTILITY COMPANY. (NOTE: PHONE AND CABLE T.V. SERVICES MAY ALSO BE LOCATED ON OVERHEAD LINES.)
- 12. THE CONTRACTOR IS RESPONSIBLE FOR THE REMOVAL AND REPLACEMENT OF SIGNS AND SUPPORTS WITHIN THE WORK AREA, AS NECESSARY TO FACILITATE CONSTRUCTION. SIGNS SHALL BE PROTECTED OR STOCKPILED FOR REUSE AS SPECIFIED IN THE PLANS OR AS REQUIRED BY THE AGENCY OF JURISDICTION. THE CONTRACTOR SHALL REPLACE ANY DAMAGED SIGNS AND SUPPORTS AT NO ADDITIONAL COST TO THE OWNER.
- 13. THE CONTRACTOR SHALL NOTIFY THE APPROPRIATE 811/ONE CALL UTILITY LOCATING CENTER, THE CITY ENGINEER AND/OR THE AUTHORITY HAVING JURISDICTION 3 BUSINESS DAYS PRIOR TO THE BEGINNING OF CONSTRUCTION.

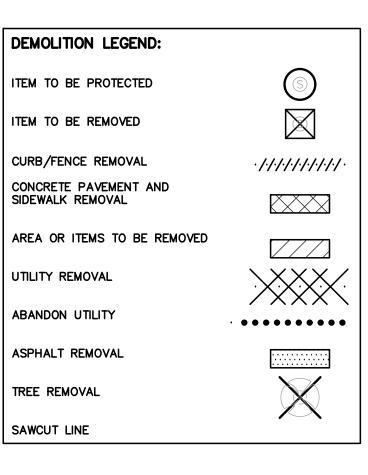










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DEVELOPMENT 1321 S. WESTNEDGE AVENUE KALAMAZOO, MICHIGAN 49008

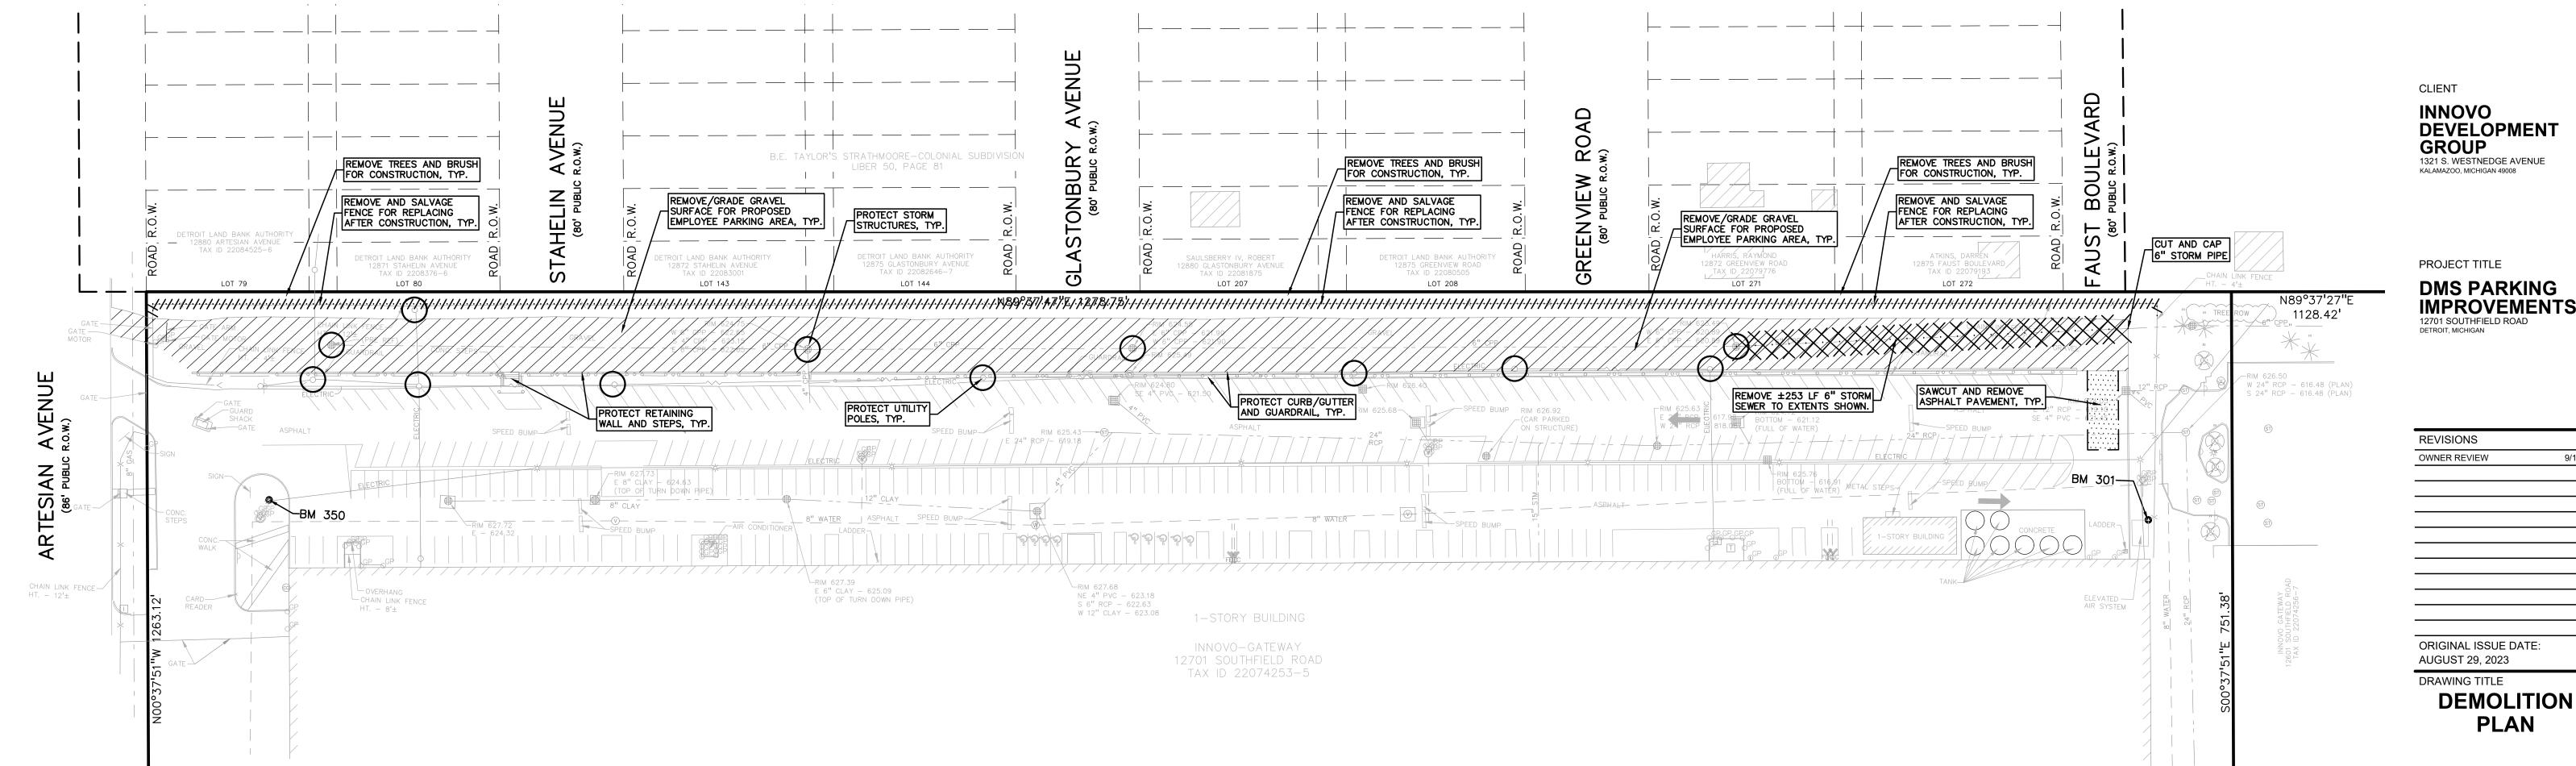DMS PARKING IMPROVEMENTS

ORIGINAL ISSUE DATE:

23-0789 PEA JOB NO. MRM DLB DES. DLB DRAWING NUMBER:

LEGAL DESCRIPTION:

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GENERAL NOTES:

THESE NOTES APPLY TO ALL CONSTRUCTION ACTIVITIES ON THIS PROJECT.

- ALL DIMENSIONS SHOWN ARE TO BACK OF CURB, FACE OF SIDEWALK, OUTSIDE FACE OF BUILDING, PROPERTY LINE, CENTER OF MANHOLE/CATCH BASIN OR CENTERLINE OF PIPE UNLESS OTHERWISE NOTED.
- 2. CURB RADIUS IS 5' UNLESS OTHERWISE NOTED.
- 3. REFER TO NOTES & DETAILS SHEET FOR ON-SITE PAVING DETAILS.

SITE DATA TABLE:

SITE AREA: 39.32 ACRES (1,712,803 SQ.FT.) NET AND GROSS

ZONING: M4 - INTENSIVE INDUSTRIAL/M2 - RESTRICTED INDUSTRIAL/ PD - PLANNED DEVELOPMENT

PROPOSED USE: EMPLOYEE PARKING FOR EXISTING INDUSTRIAL USE

SETBACK REQUIREMENTS:
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PROPOSED LANDSCAPING AND PARKING, WHICH IS SETBACK TEN (10) FEET TO THE NORTH PROPERTY LINE WITHIN THE PD ZONING DISTRICT.

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PROPOSED PARKING PROVIDED:

98 ANGLED EMPLOYEE PARKING SPACES PER CITY STANDARDS

SITE SOILS INFORMATION:
ACCORDING TO THE USDA NATURAL RESOURCES CONSERVATION SERVICE WEB SOIL

SURVEY FOR WAYNE COUNTY, THE SITE CONSISTS OF THE FOLLOWING SOIL TYPES: UrbaqB - URBAN LAND - RIVERFRONT COMPLEX, 0 TO 4% SLOPES

LEGEND:

CONCRETE PAVEMENT


ASPHALT PAVEMENT

CONCRETE CURB AND GUTTER REVERSE GUTTER PAN

— - · - — - · - — SETBACK LINE LIGHTPOLE ____X FENCE GUARD RAIL


www.peagroup.com



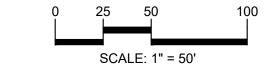




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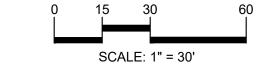


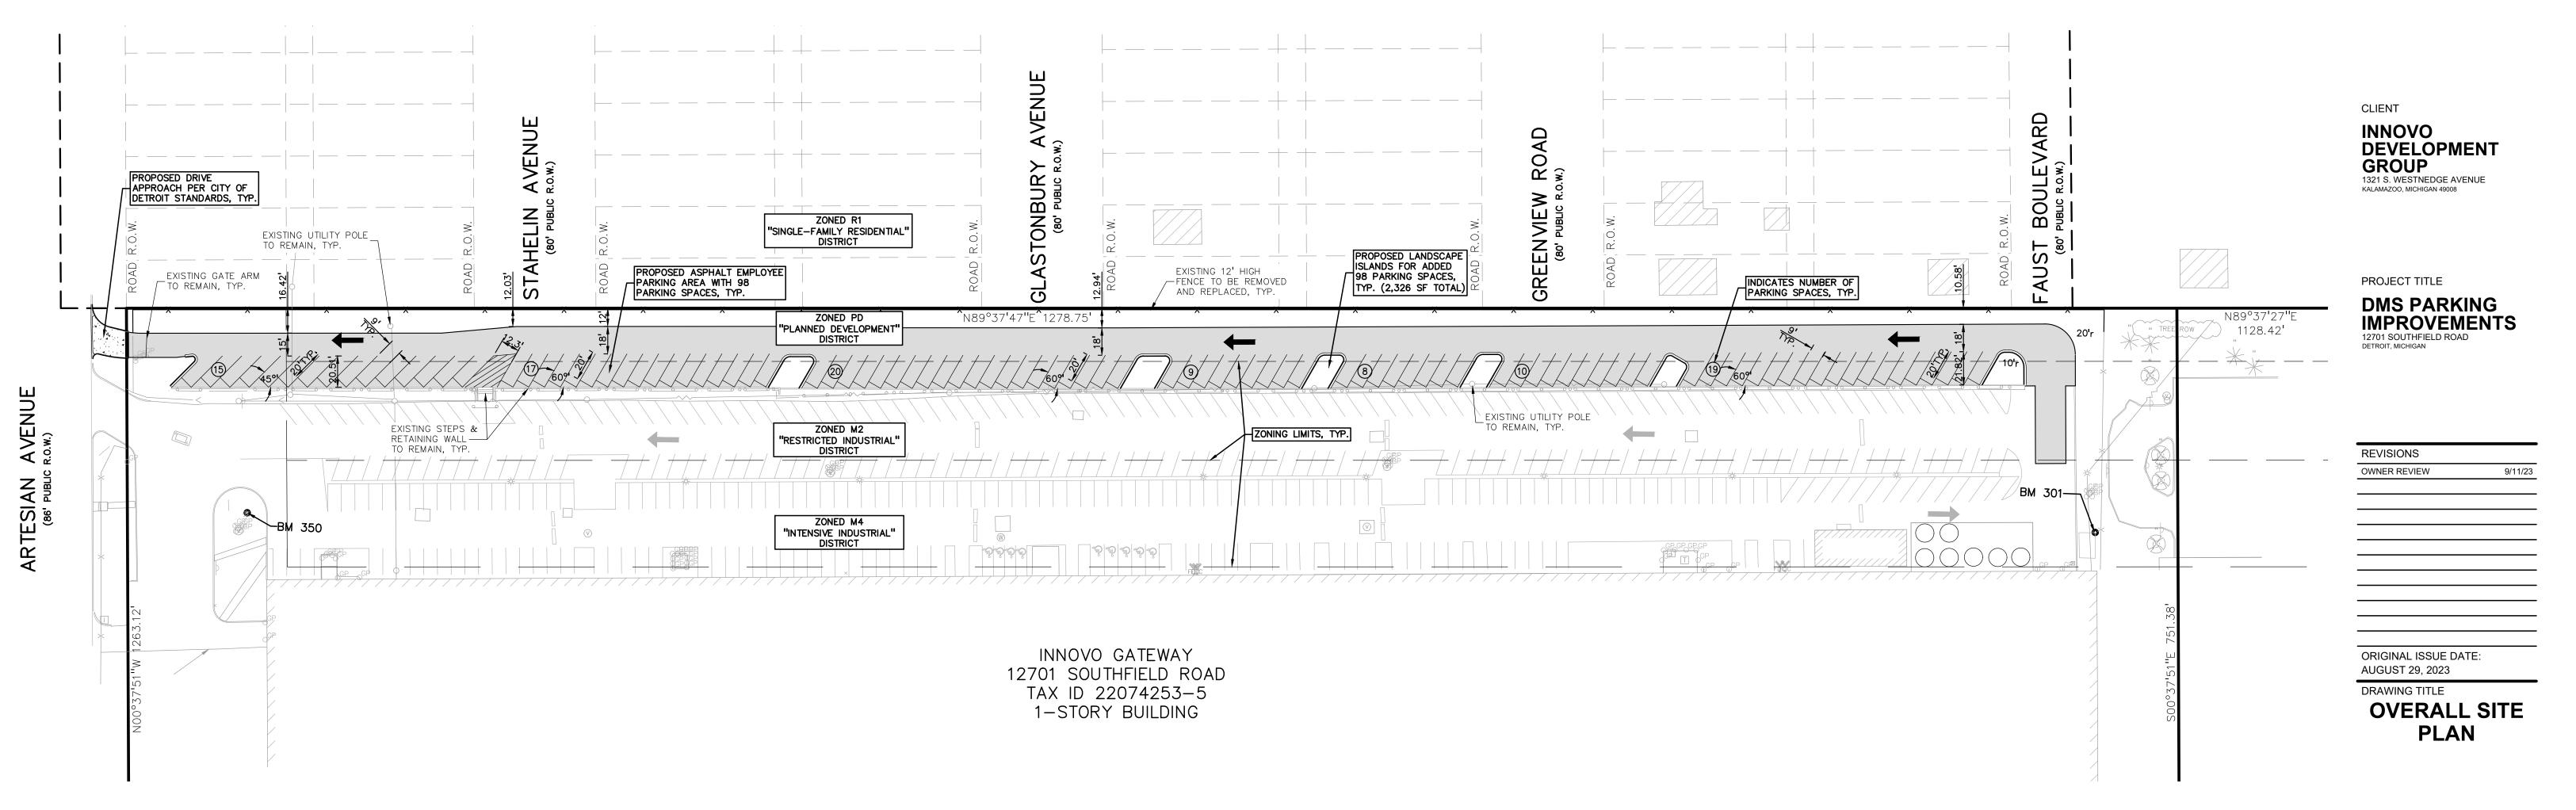23-0789 PEA JOB NO. MRM DLB DES. DLB DRAWING NUMBER:



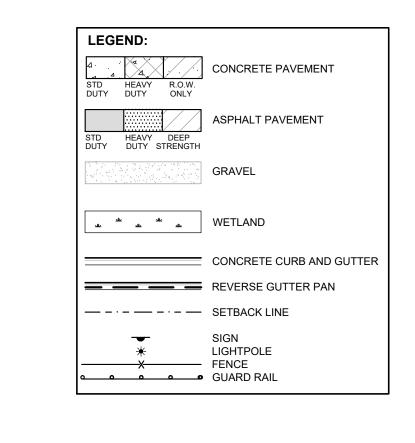







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CLIENT

INNOVO DEVELOPMENT GROUP 1321 S. WESTNEDGE AVENUE KALAMAZOO, MICHIGAN 49008

PROJECT TITLE

DMS PARKING IMPROVEMENTS 12701 SOUTHFIELD ROAD DETROIT, MICHIGAN

REVISIONS
OWNER REVIEW
9/11/23

ORIGINAL ISSUE DATE: AUGUST 29, 2023 DRAWING TITLE

DIMENSION & PAVING PLAN - 1


PEA JOB NO. 23-0789


P.M. MRM


DN. DLB

DES. DLB

DRAWING NUMBER:

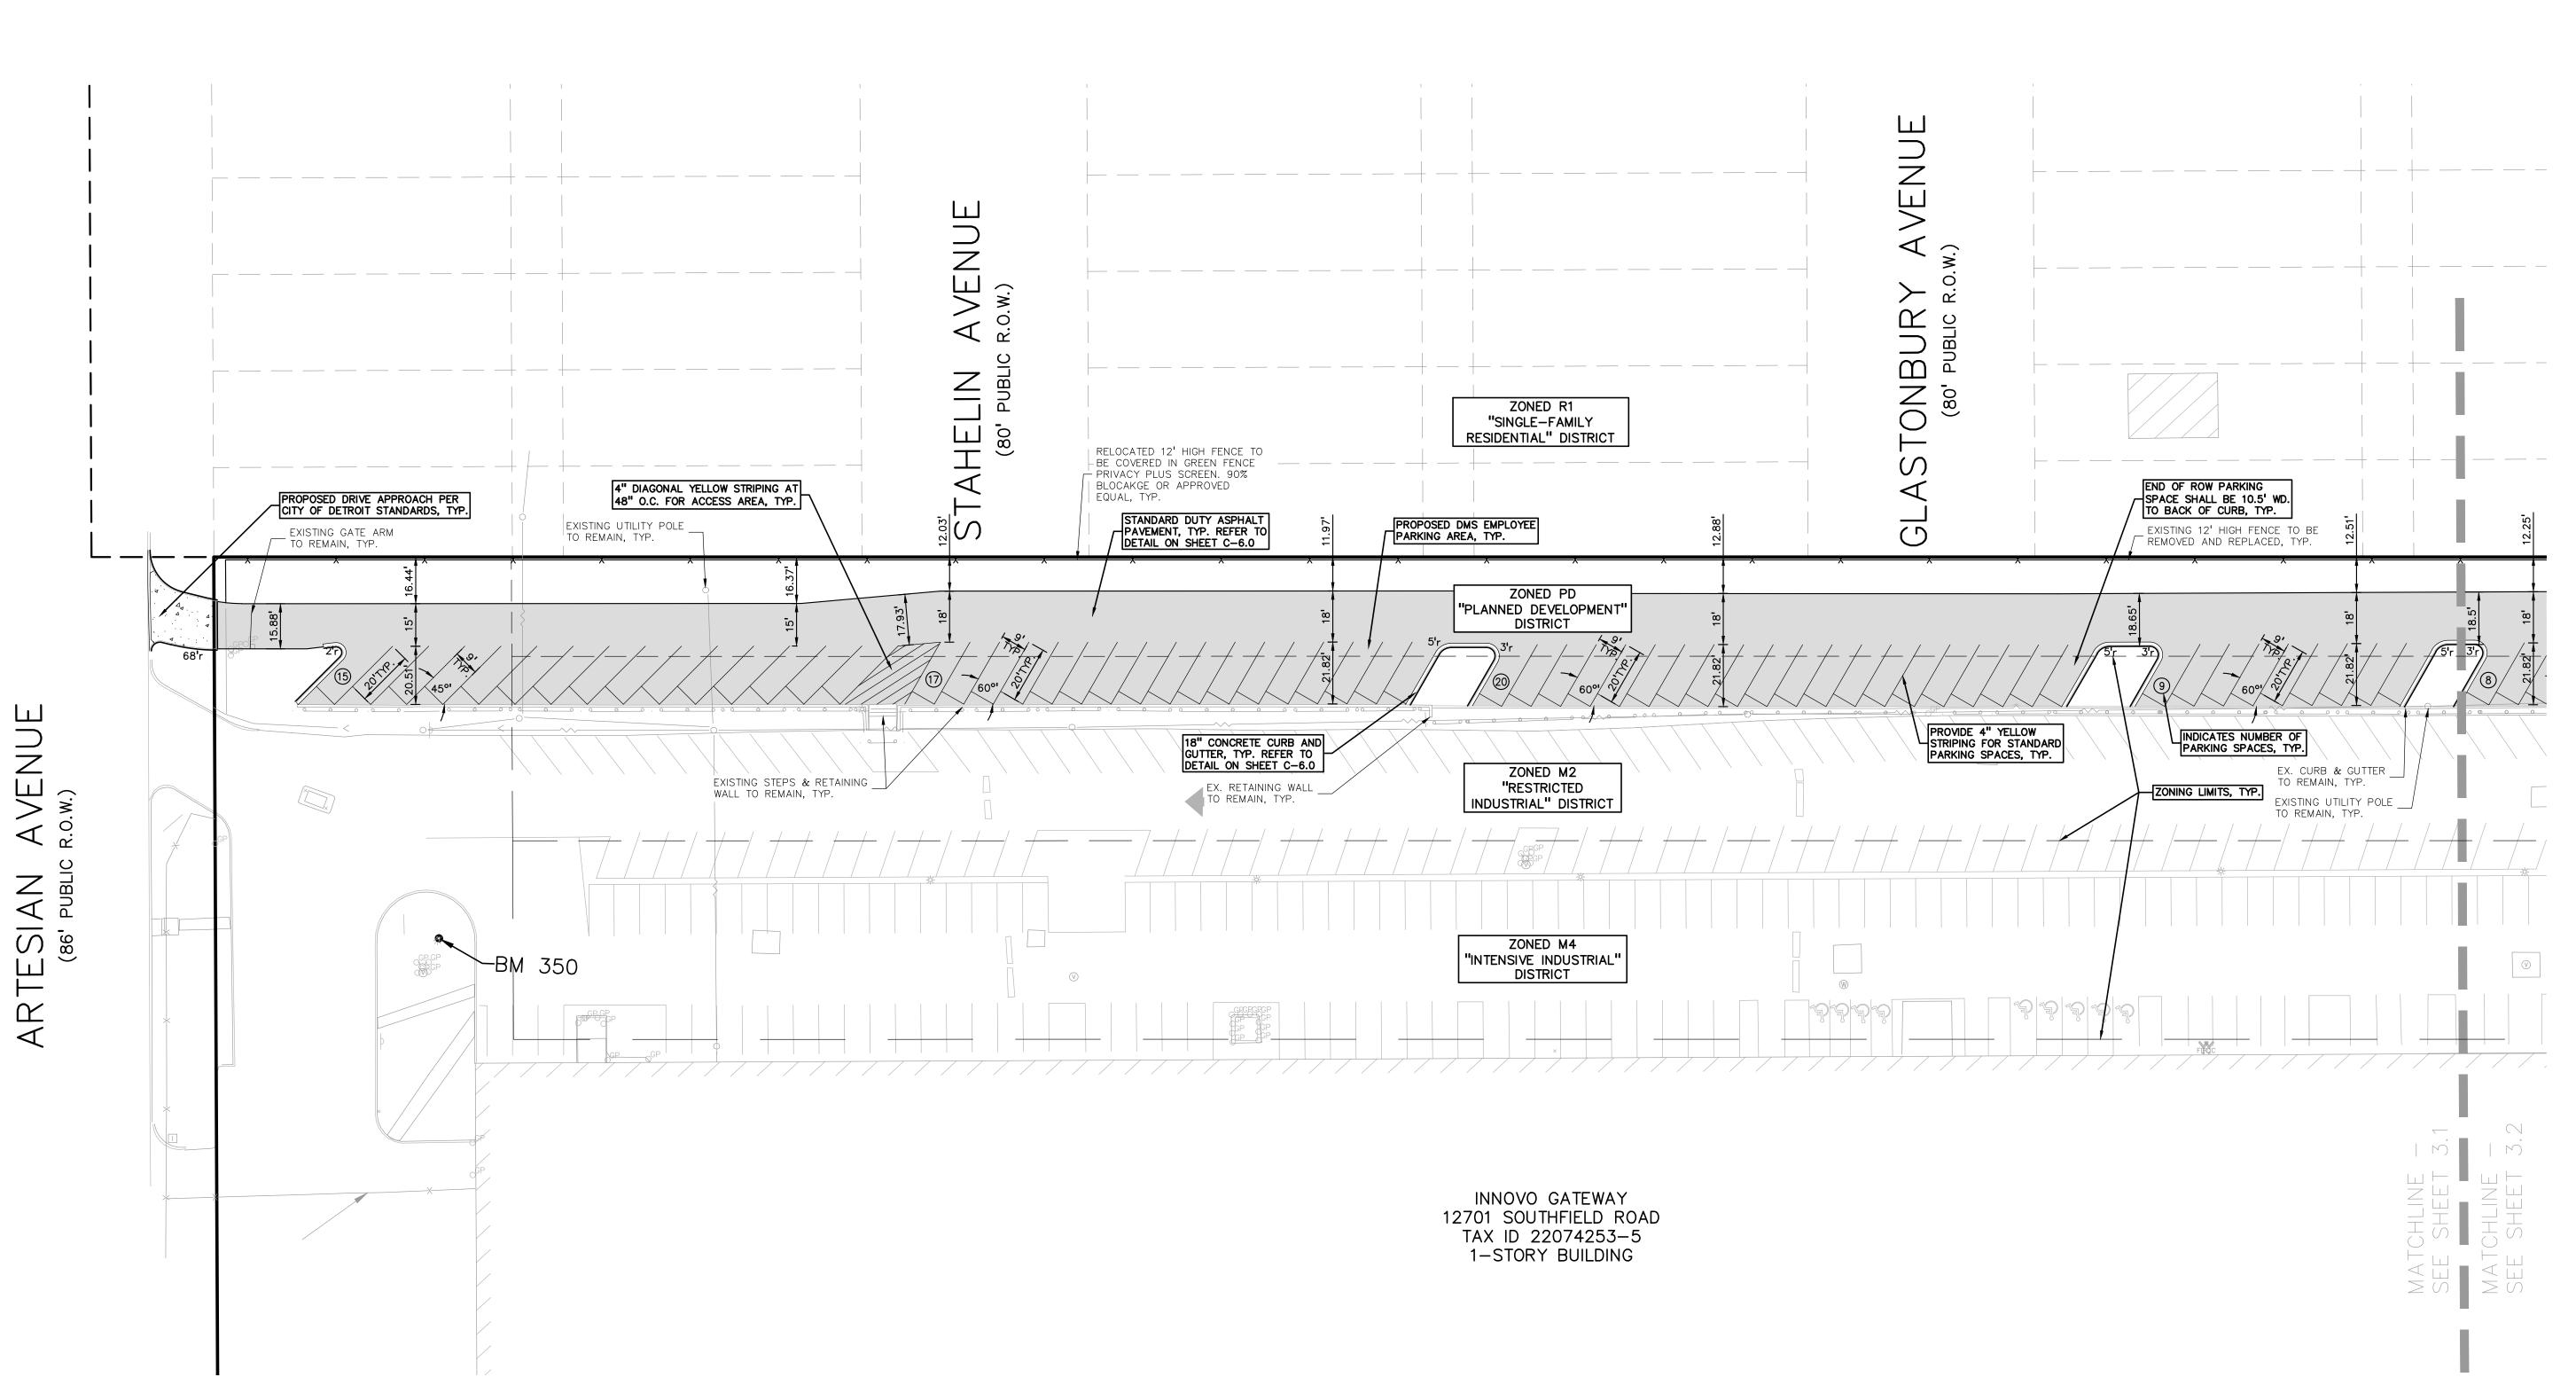


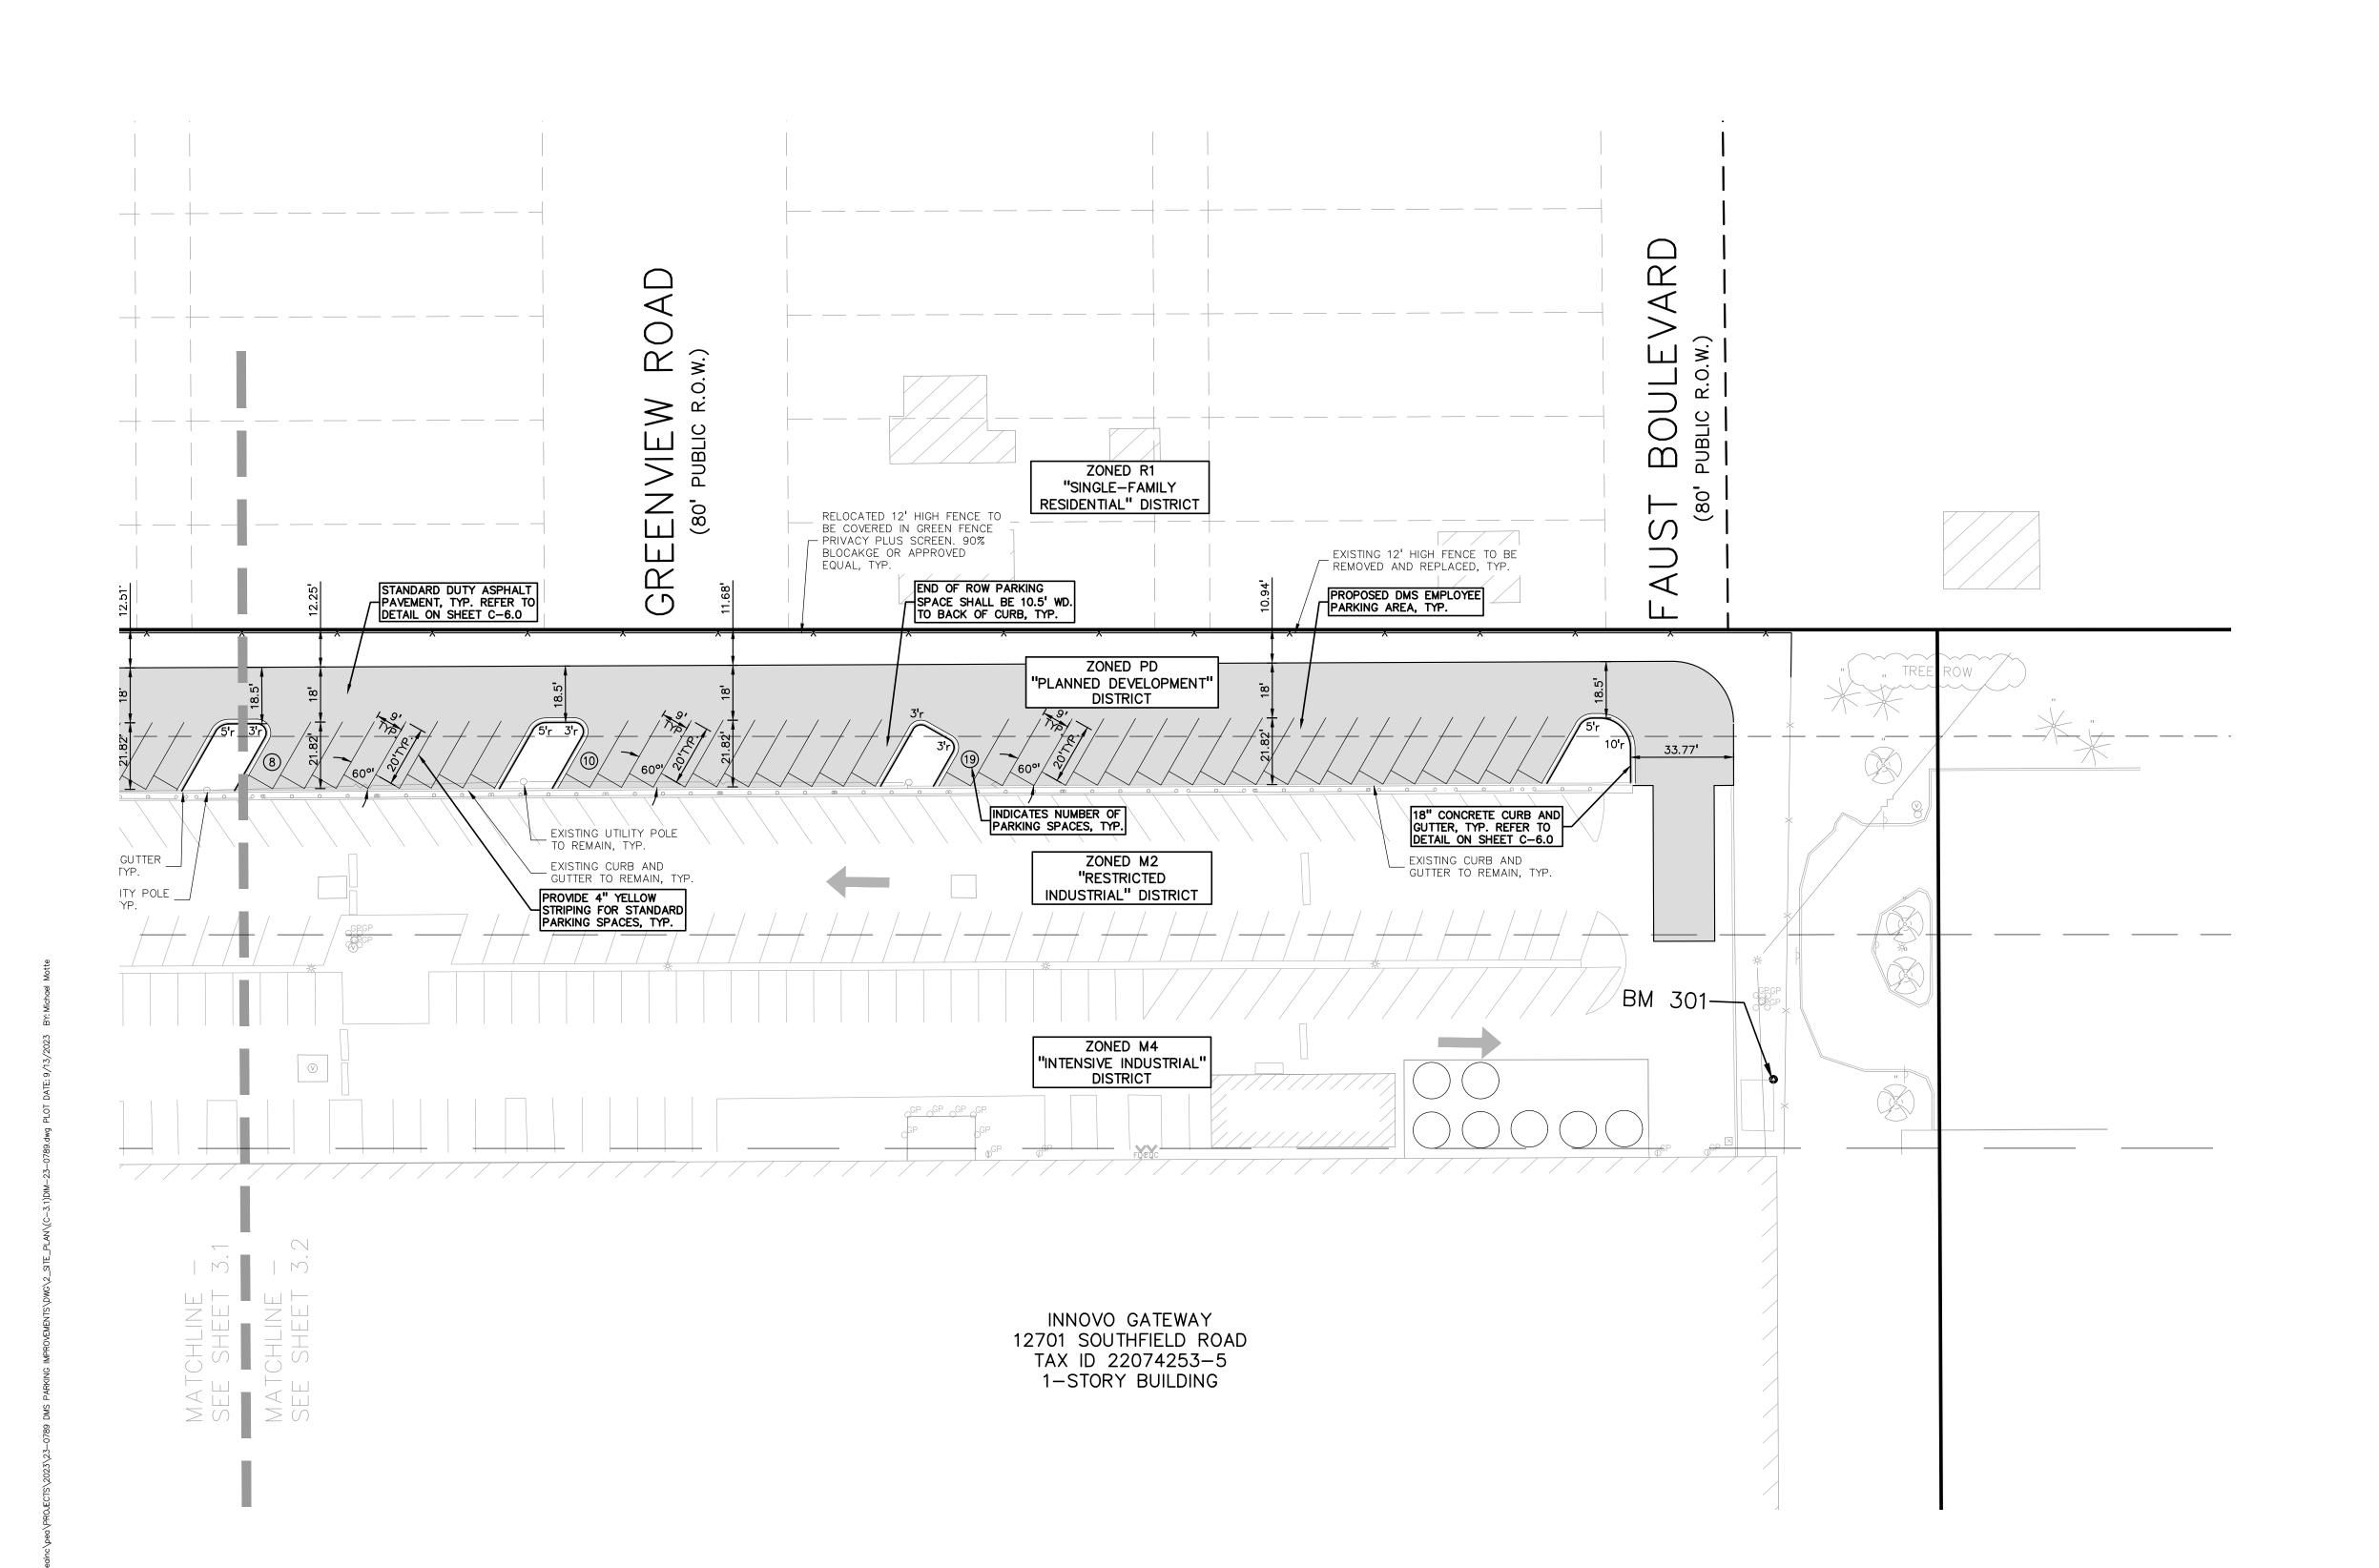

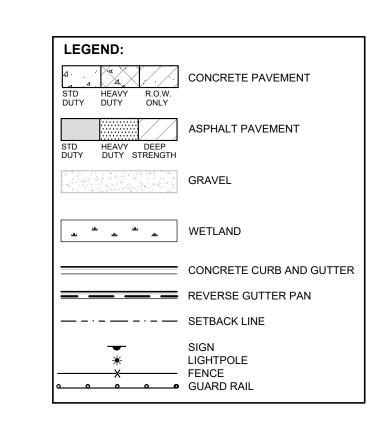





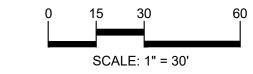



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INNOVO DEVELOPMENT GROUP 1321 S. WESTNEDGE AVENUE KALAMAZOO, MICHIGAN 49008

PROJECT TITLE

DMS PARKING IMPROVEMENTS 12701 SOUTHFIELD ROAD DETROIT, MICHIGAN

REVISIONS	
OWNER REVIEW	9/11/23
ORIGINAL ISSUE DATE:	

DRAWING TITLE

DIMENSION & PAVING PLAN - 2

PEA JOB NO.	23-0789
P.M.	MRM
DN.	DLE
DES.	DLE
DRAWING NUMBER:	

NOT FOR CONSTRUCTION

C-3.2

BENCHMARKS

(NAVD 88, GPS DERIVED)

BM 301

NORTHEAST BOLT ON NORTHEAST COLUMN OF BUILDING A. 30' NORTH OF NORTHEAST BUILDING CORNER AND 1300' EAST OF CENTER LINE OF ARTESIAN STREET. ELEVATION — 628.62

BM 350

"+" ON TOP OF LIGHT POLE CONCRETE BASE. LIGHT IS 45'± NORTHWEST OF CORNER OF THE MAIN BUILDING ON THE SUBJECT PROPERTY.

ELEVATION - 628.86

EARTHWORK BALANCING NOTE:

THE CONTRACTOR SHALL BE RESPONSIBLE FOR IMPORTING OR EXPORTING ALL MATERIALS AS REQUIRED TO PROPERLY GRADE THIS PROJECT TO THE FINISHED ELEVATIONS SHOWN ON THE APPROVED PLANS. THE CONTRACTOR SHALL MAKE THEIR OWN DETERMINATION OF CUT AND FILL QUANTITIES AND ALLOW FOR REMOVAL OF EXCESS OR IMPORTATION OF ADDITIONAL MATERIAL AT NO ADDITIONAL COST TO THE OWNER.

GRADING LEGEND:

EXISTING SPOT ELEVATION

PROPOSED SPOT ELEVATION:
TYPICALLY TOP OF PAVEMENT
IN PAVED AREAS, GUTTER GRADE
IN CURB LINES.

EXISTING CONTOUR

PROPOSED CONTOUR

PROPOSED REVERSE GUTTER PAN

PROPOSED RIDGE LINE

PROPOSED SWALE/DITCH

ABBREVIATIONS

T/C = TOP OF CURB
T/P = TOP OF PAVEMENT
FG = FINISH GRADE

PEA GROUP t: 844.813.2949 www.peagroup.com

RETAINING WALL NOTE:

TOP OF WALL (T/W) AND BOTTOM OF WALL (B/W)
GRADES ARE THE FINISH GRADE AT THE TOP AND
BOTTOM OF THE RETAINING WALL, NOT ACTUAL TOP
AND BOTTOM OF THE WALL STRUCTURE.


REFER TO GRADING NOTES ON SHEET C-4.2.

T/S = TOP OF SIDEWALK RIM = RIM ELEVATION


T/W = TOP OF WALL

B/W = BOTTOM OF WALL



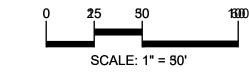



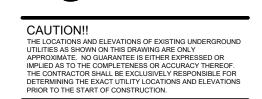

INNOVO
DEVELOPMENT
GROUP

1321 S. WESTNEDGE AVENUE
KALAMAZOO, MICHIGAN 49008

PROJECT TITLE


DMS PARKING IMPROVEMENTS 12701 SOUTHFIELD ROAD DETROIT, MICHIGAN

REVISIONS	
OWNER REVIEW	9/11/23
ORIGINAL ISSUE DAT	 TE:
AUGUST 29, 2023	·

DRAWING TITLE
PRELIMINARY
GRADING PLAN -

1PEA JOB NO. 23-0789

DN. DLB
DES. DLB
DRAWING NUMBER:

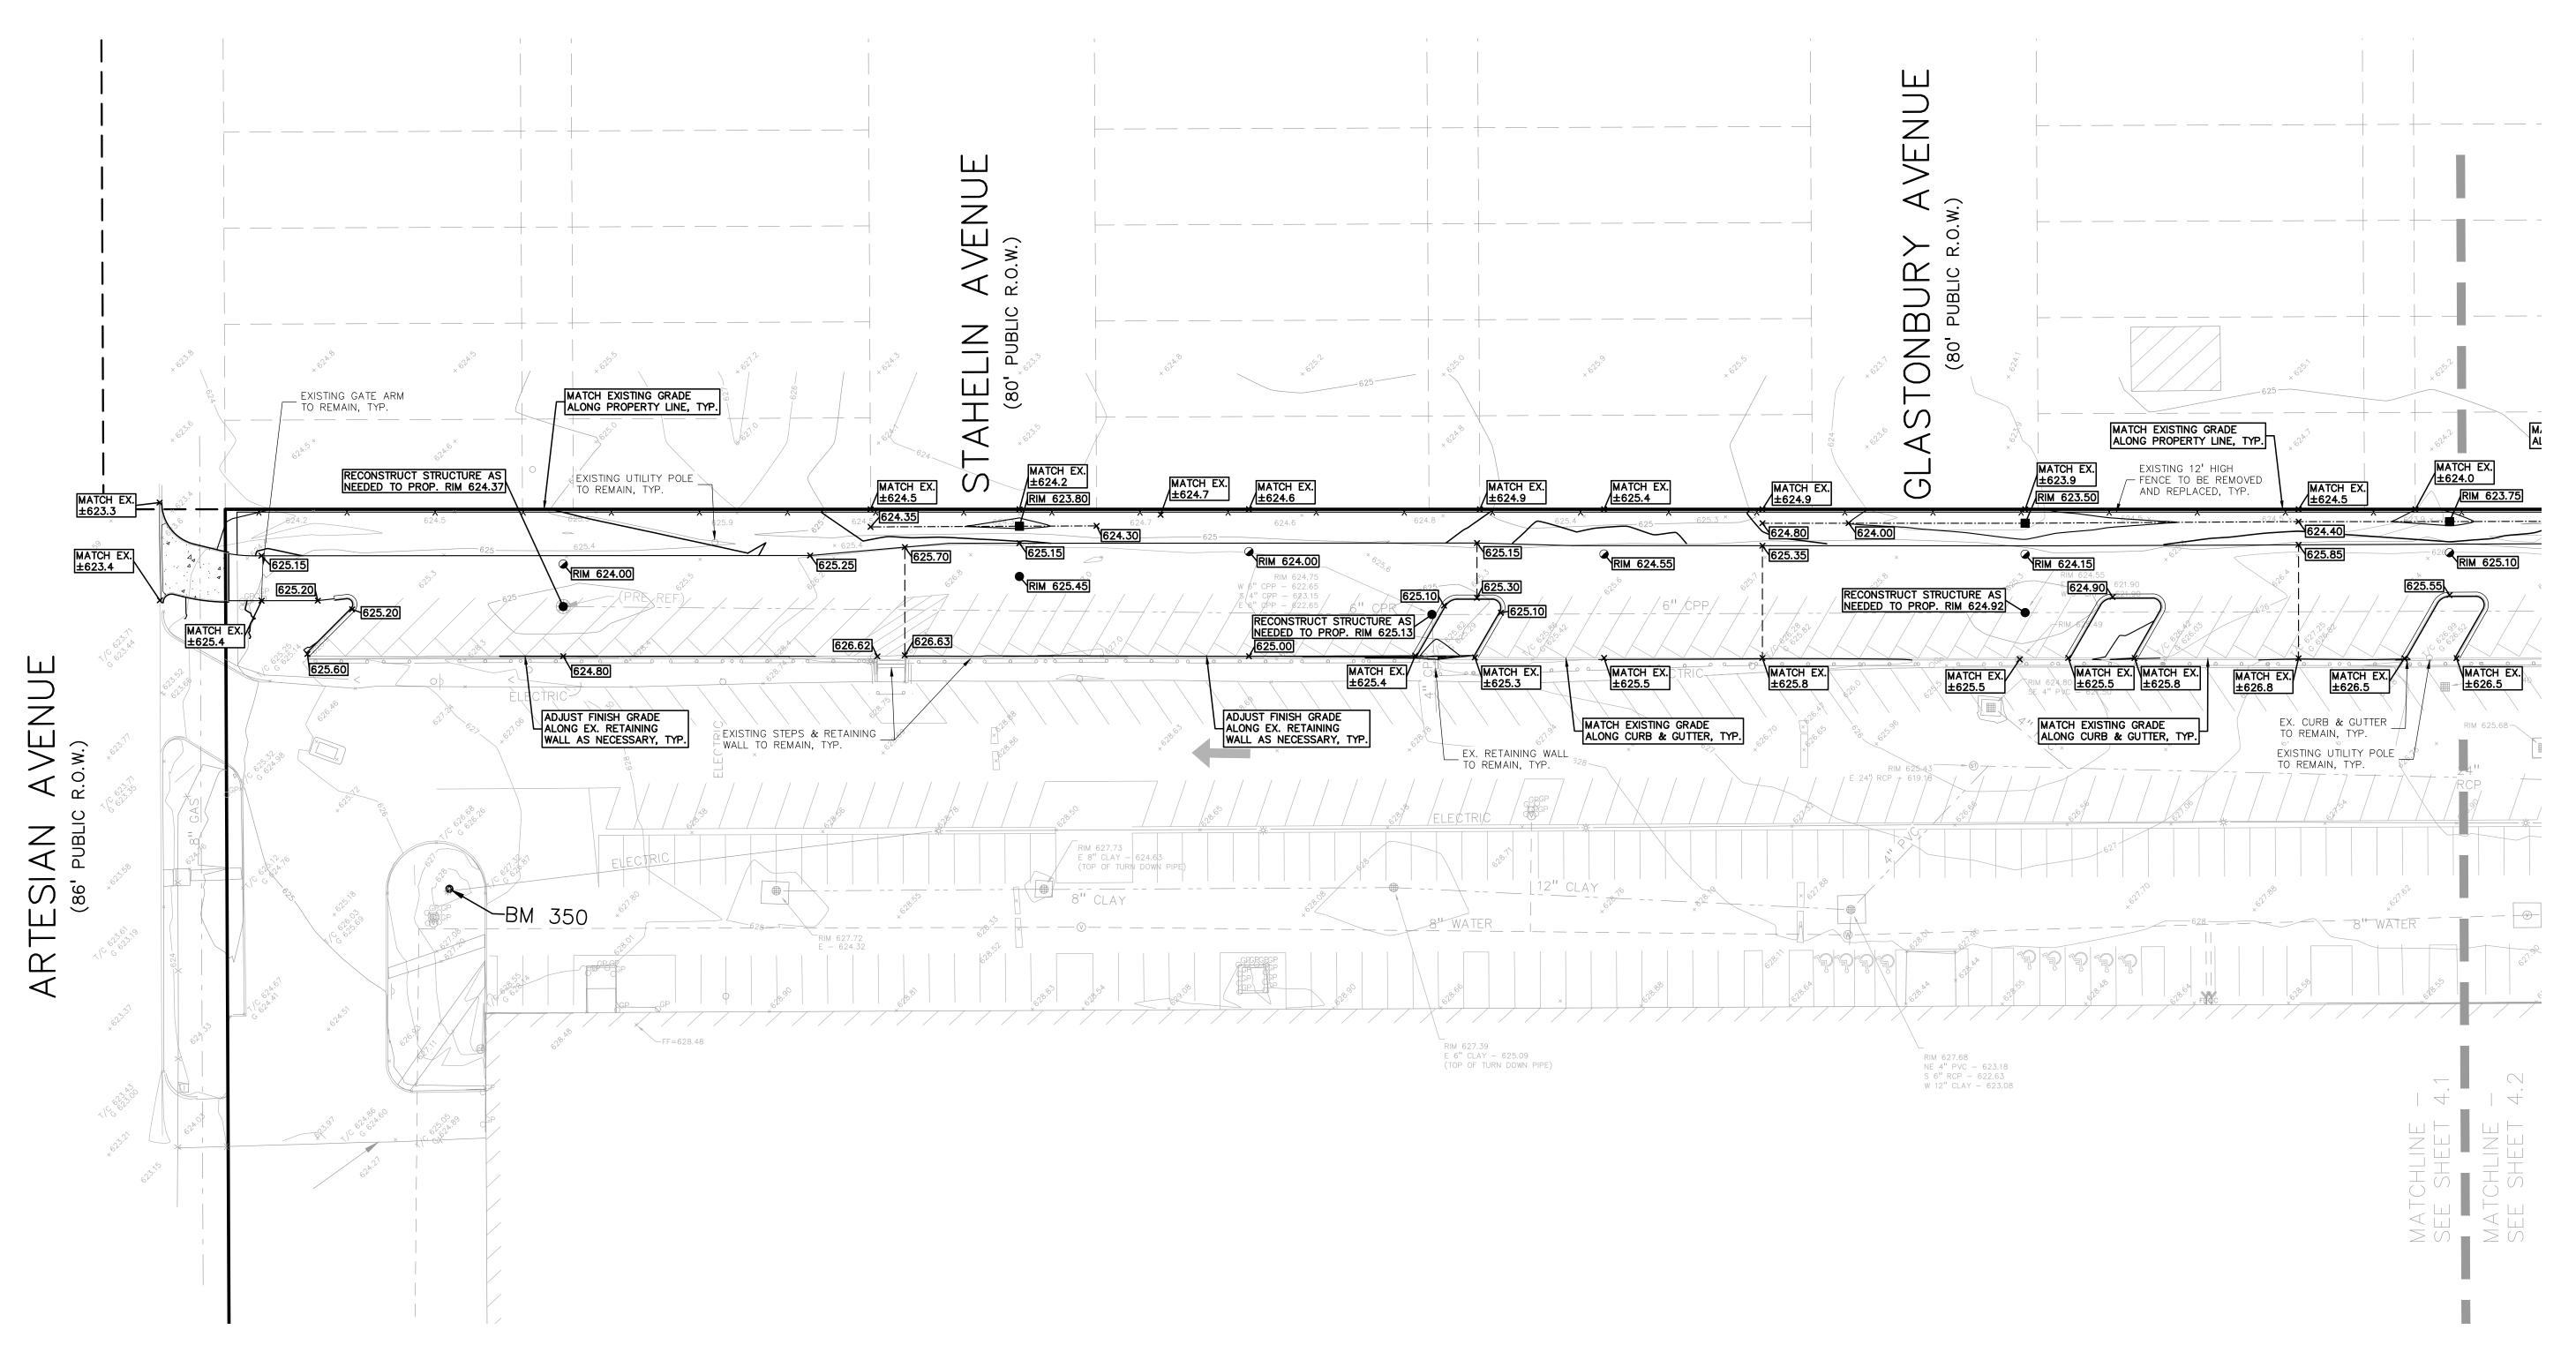

MRM

GENERAL GRADING AND EARTHWORK NOTES:

THESE NOTES APPLY TO ALL CONSTRUCTION ACTIVITIES ON THIS PROJECT

- CONTRACTOR SHALL FIELD VERIFY ALL EXISTING TREES AND BRUSH AND REMOVE ALL THAT ARE NECESSARY TO GRADE SITE.
- 2. ALL GRADES ARE TO TOP OF PAVEMENT UNLESS OTHERWISE NOTED. 3. THE STAGING OF CONSTRUCTION ACTIVITIES SHALL OCCUR ONLY WITHIN THE SITE BOUNDARIES. ANY CONSTRUCTION ACTIVITIES OUTSIDE
- OF THE SITE BOUNDARIES SHALL BE AT THE SOLE RESPONSIBILITY AND RISK OF THE CONTRACTOR. . ALL SOIL EROSION AND SEDIMENTATION CONTROL MEASURES SHALL MEET THE REQUIREMENTS OF THE AUTHORIZED PUBLIC AGENCY OF JURISDICTION. AN EROSION CONTROL PERMIT MUST BE SECURED FROM WAYNE COUNTY PRIOR TO CONSTRUCTION.
- 5. ALL EARTHWORK AND GRADING OPERATIONS SHALL BE PERFORMED IN ACCORDANCE WITH THE SOILS INVESTIGATION AND REPORT.
- 6. REFER TO SOIL EROSION CONTROL PLAN FOR ADDITIONAL SOIL EROSION AND SEDIMENTATION CONTROL MEASURES AND NOTES.
- 7. ALL SLOPE EXCEEDING 1:6 MUST BE STABILIZED BY SODDING OR BY PLACING A MULCH BLANKET PEGGED IN PLACE OVER SEED.
- 8. ALL DISTURBED AREAS SHALL BE SEEDED AND MULCHED OR SODDED IN ACCORDANCE WITH THE LANDSCAPE PLANS. PROVIDE A MINIMUM OF 3" OF TOPSOIL IN THESE AREAS UNLESS OTHERWISE NOTED.
- THE CONTRACTOR SHALL NOTE EXISTING UNDERGROUND UTILITIES WITHIN AND ADJACENT TO THE SITE. BACKFILL FOR EXISTING UTILITY TRENCHES SHALL BE EXAMINED CRITICALLY. ANY TRENCHES FOUND TO HAVE SOFT, UNSTABLE OR UNSUITABLE BACKFILL MATERIAL, IN THE OPINION OF THE THIRD PARTY TESTING COMPANY, THAT ARE TO BE WITHIN THE ZONE OF INFLUENCE OF PROPOSED BUILDINGS OR PAVEMENT SHALL BE COMPLETELY EXCAVATED AND BACKFILLED WITH SUITABLE MATERIAL.
- 10. ON-SITE FILL CAN BE USED IF THE SPECIFIED COMPACTION REQUIREMENTS CAN BE ACHIEVED. IF ON-SITE SOIL IS USED, IT SHOULD BE CLEAN AND FREE OF FROZEN SOIL, ORGANICS, OR OTHER DELETERIOUS MATERIALS.
- 1. THE FINAL SUBGRADE/EXISTING AGGREGATE BASE SHOULD BE THOROUGHLY PROOFROLLED USING A FULLY LOADED TANDEM AXLE TRUCK OR FRONT END LOADER UNDER THE OBSERVATION OF A GEOTECHNICAL/PAVEMENT ENGINEER. LOOSE OR YIELDING AREAS THAT CANNOT BE MECHANICALLY STABILIZED SHOULD BE REINFORCED USING GEOGRIDS OR REMOVED AND REPLACED WITH ENGINEERED FILL OR AS DICTATED BY FIELD CONDITIONS.
- 12. SUBGRADE UNDERCUTTING, INCLUDING BACKFILLING SHALL BE PERFORMED TO REPLACE MATERIALS SUSCEPTIBLE TO FROST HEAVING AND UNSTABLE SOIL CONDITIONS. ANY EXCAVATIONS THAT MAY BE REQUIRED BELOW THE TOPSOIL IN FILL AREAS OR BELOW PROPOSED SUBGRADE IN CUT AREAS WILL BE CLASSIFIED AS SUBGRADE UNDERCUTTING.
- 13. SUBGRADE UNDERCUTTING SHALL BE PERFORMED WHERE NECESSARY AND THE EXCAVATED MATERIAL SHALL BECOME THE PROPERTY OF THE CONTRACTOR. ANY SUBGRADE UNDERCUTTING SHALL BE BACKFILLED AS RECOMMENDED IN THE GEOTECHNICAL ENGINEERING REPORT FOR THE PROJECT.
- 14. ANY SUBGRADE WATERING REQUIRED TO ACHIEVE REQUIRED DENSITY SHALL BE CONSIDERED INCIDENTAL TO THE JOB.

BENCHMARKS


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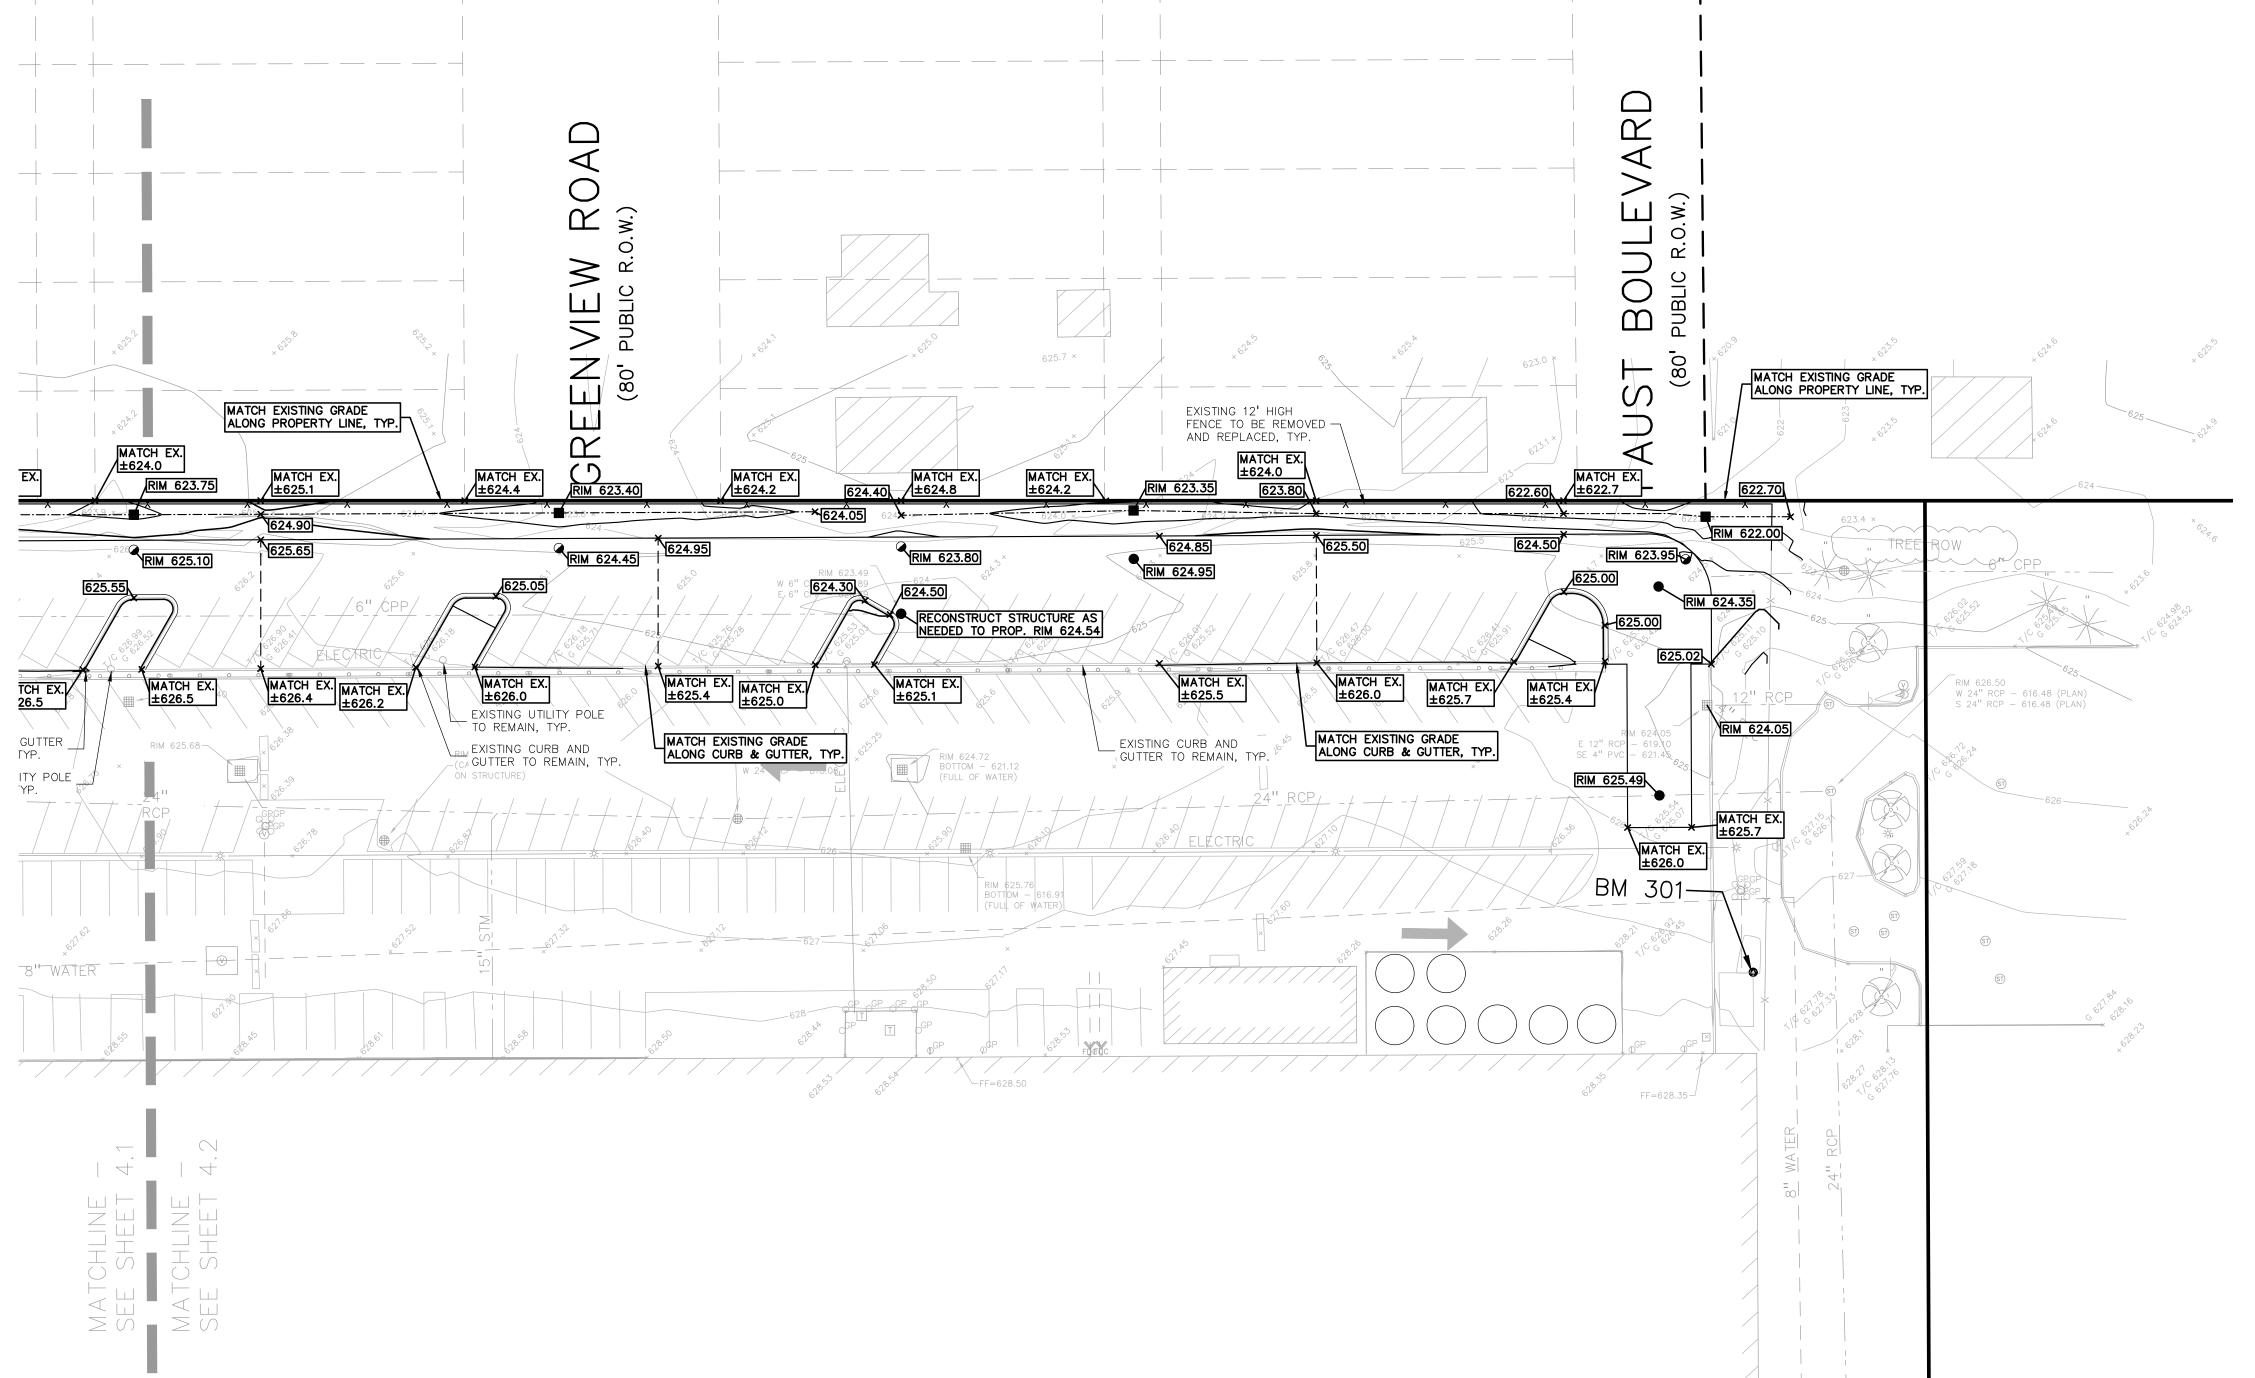
BM 301


BUILDING CORNER AND 1300' EAST OF CENTER LINE OF ARTESIAN STREET. ELEVATION - 628.62

BM 350

"+" ON TOP OF LIGHT POLE CONCRETE BASE. LIGHT IS 45'± NORTHWEST OF CORNER OF THE MAIN BUILDING ON THE SUBJECT PROPERTY. ELEVATION - 628.86



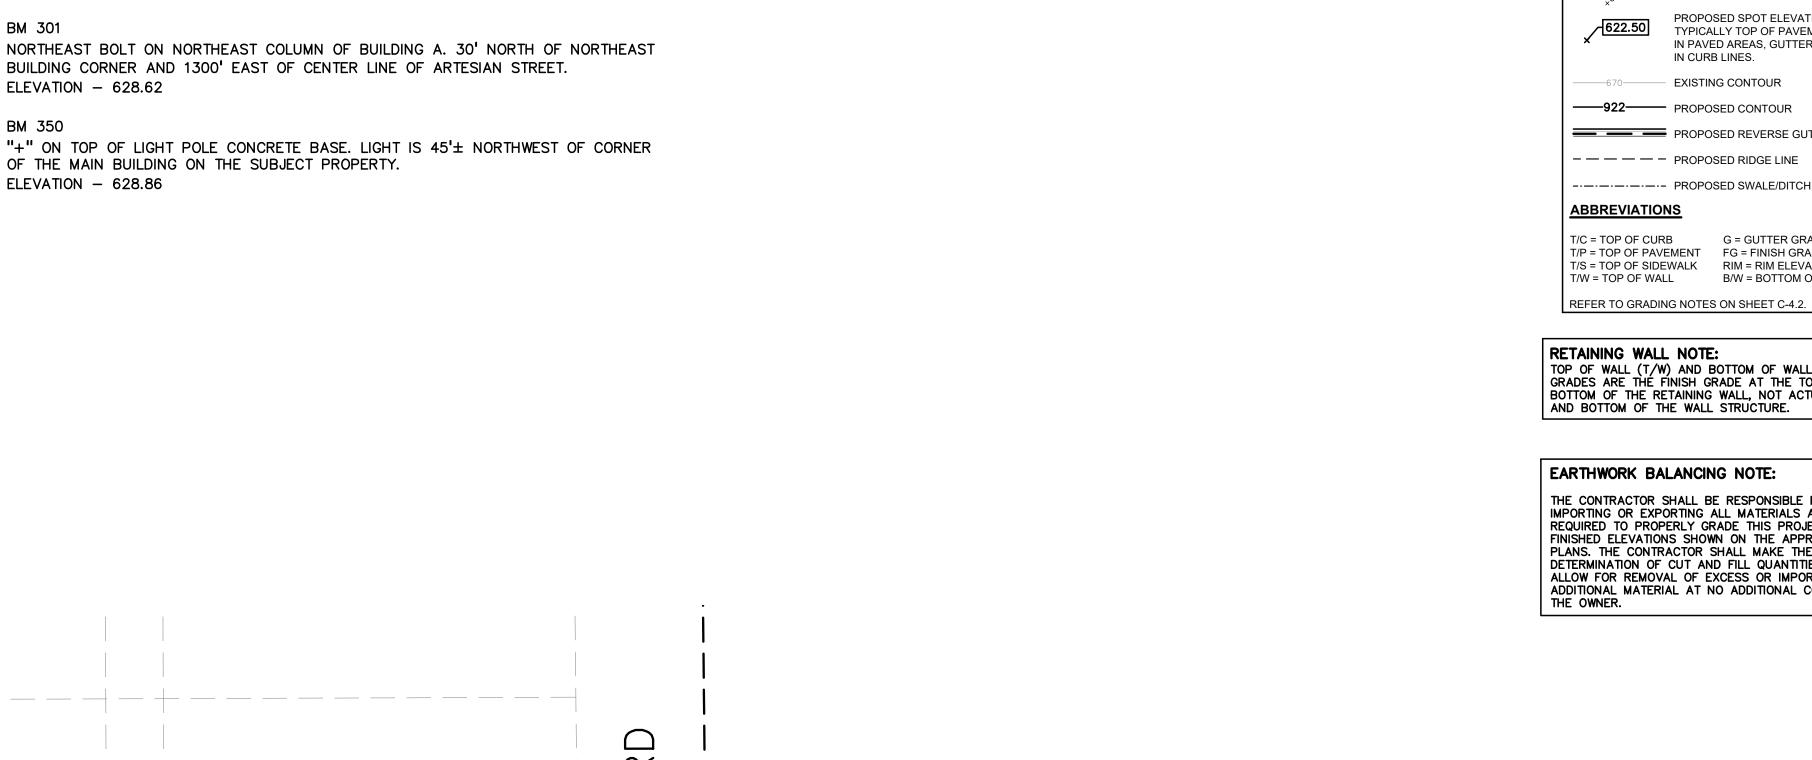

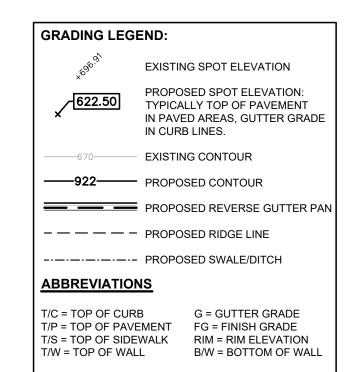




RETAINING WALL NOTE: TOP OF WALL (T/W) AND BOTTOM OF WALL (B/W) GRADES ARE THE FINISH GRADE AT THE TOP AND BOTTOM OF THE RETAINING WALL, NOT ACTUAL TOP AND BOTTOM OF THE WALL STRUCTURE.

EARTHWORK BALANCING NOTE:

THE CONTRACTOR SHALL BE RESPONSIBLE FOR IMPORTING OR EXPORTING ALL MATERIALS AS REQUIRED TO PROPERLY GRADE THIS PROJECT TO THE FINISHED ELEVATIONS SHOWN ON THE APPROVED PLANS. THE CONTRACTOR SHALL MAKE THEIR OWN DETERMINATION OF CUT AND FILL QUANTITIES AND ALLOW FOR REMOVAL OF EXCESS OR IMPORTATION OF ADDITIONAL MATERIAL AT NO ADDITIONAL COST TO



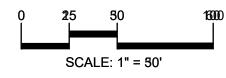



CAUTION!! THE LOCATIONS AND ELEVATIONS OF EXISTING UNDERGROUND UTILITIES AS SHOWN ON THIS DRAWING ARE ONLY APPROXIMATE. NO GUARANTEE IS EITHER EXPRESSED OR IMPLIED AS TO THE COMPLETENESS OR ACCURACY THEREOF. THE CONTRACTOR SHALL BE EXCLUSIVELY RESPONSIBLE FOR DETERMINING THE EXACT UTILITY LOCATIONS AND ELEVATIONS PRIOR TO THE START OF CONSTRUCTION.

CLIENT

INNOVO DEVELOPMENT GROUP 1321 S. WESTNEDGE AVENUE KALAMAZOO, MICHIGAN 49008

PROJECT TITLE

DMS PARKING IMPROVEMENTS 12701 SOUTHFIELD ROAD DETROIT, MICHIGAN

REVISIONS	
OWNER REVIEW	9/11/23
	_
ORIGINAL ISSUE DATE:	

DRAWING TITLE **PRELIMINARY GRADING PLAN -**

AUGUST 29, 2023

PEA JOB NO.	23-0789
P.M.	MRM
DN.	DLB
DES.	DLB

DRAWING NUMBER:

NOT FOR CONSTRUCTION


GENERAL UTILITY NOTES:

- ALL WORKMANSHIP AND MATERIALS SHALL BE IN ACCORDANCE WITH THE STANDARDS AND SPECIFICATIONS OF THE CITY OF
- . ALL TRENCHES UNDER OR WITHIN THREE (3) FEET OR THE FORTY-FIVE (45) DEGREE ZONE OF INFLUENCE LINE OF EXISTING AND/OR PROPOSED PAVEMENT, BUILDING PAD OR DRIVE APPROACH SHALL BE BACKFILLED WITH GRANULAR FILL COMPACTED TO AT LEAST NINETY-FIVE (95) PERCENT OF MAXIMUM UNIT WEIGHT (ASTM D-1557). ALL OTHER TRENCHES TO BE COMPACTED TO
- . WHERE EXISTING MANHOLES OR SEWER PIPE ARE TO BE TAPPED, DRILL HOLES 4" CENTER TO CENTER, AROUND PERIPHERY OF OPENING TO CREATE A PLANE OF WEAKNESS JOINT BEFORE BREAKING SECTION OUT.
- THE LOCATIONS AND DIMENSIONS SHOWN ON THE PLANS FOR EXISTING UTILITIES ARE IN ACCORDANCE WITH AVAILABLE INFORMATION WITHOUT UNCOVERING AND MEASURING. THE DESIGN ENGINEER DOES NOT GUARANTEE THE ACCURACY OF THIS INFORMATION OR THAT ALL EXISTING UNDERGROUND FACILITIES ARE SHOWN. CONTRACTOR SHALL FIELD VERIFY UTILITIES.
- THE CONTRACTOR SHALL COORDINATE TO ENSURE ALL REQUIRED PIPES, CONDUITS, CABLES AND SLEEVES ARE PROPERLY PLACED FOR THE INSTALLATION OF GAS, ELECTRIC, PHONE, CABLE, IRRIGATION, ETC. IN SUCH A MANNER THAT WILL FACILITATE THEIR PROPER INSTALLATION PRIOR TO THE PLACEMENT OF THE PROPOSED PAVEMENT AND LANDSCAPING.
- 6. PIPE LENGTHS INDICATED ARE FROM CENTER OF STRUCTURE AND TO END OF FLARED END SECTION UNLESS NOTED OTHERWISE.
- CONTRACTOR SHALL INSPECT ALL EXISTING PUBLIC STORM SEWER, SANITARY SEWER AND WATER MAIN STRUCTURES WITHIN THE LIMITS OF CONSTRUCTION AND WITH THE GOVERNING AGENCY INSPECTOR PRIOR TO ESTABLISHING FINAL GRADE. NOTIFY THE ENGINEER, OWNER/DEVELOPER, AND GOVERNING AGENCY IF STRUCTURE IS DEEMED TO BE STRUCTURALLY UNSOUND AND/OR IN

STORM SEWER NOTES:

- ALL STORM SEWER 12" DIAMETER OR LARGER SHALL BE HDPE DUAL WALL SMOOTH INTERIOR PIPE (HDPE) WITH REINFORCED INTEGRAL BELL AND GASKETED SPIGOT, COMPLYING WITH ASTM F2306, F2648 & D3212.
- 2. ALL STORM SEWER LEADS SHALL BE CONSTRUCTED AT 1.00% MINIMUM SLOPE.
- 3. ALL STORM SEWER 10" OR LESS AND/OR LEADS SHALL BE SDR 26 COMPLYING WITH ASTM D3034.
- 4. JOINTS FOR P.V.C. PIPE SHALL BE ELASTOMERIC (RUBBER GASKET) AS SPECIFIED IN A.S.T.M. DESIGNATION F477.

ALTERNATIVE ENGINEERED DESIGN

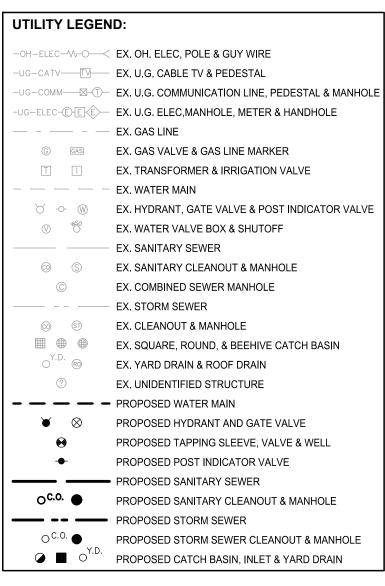










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PRIOR TO THE START OF CONSTRUCTION.

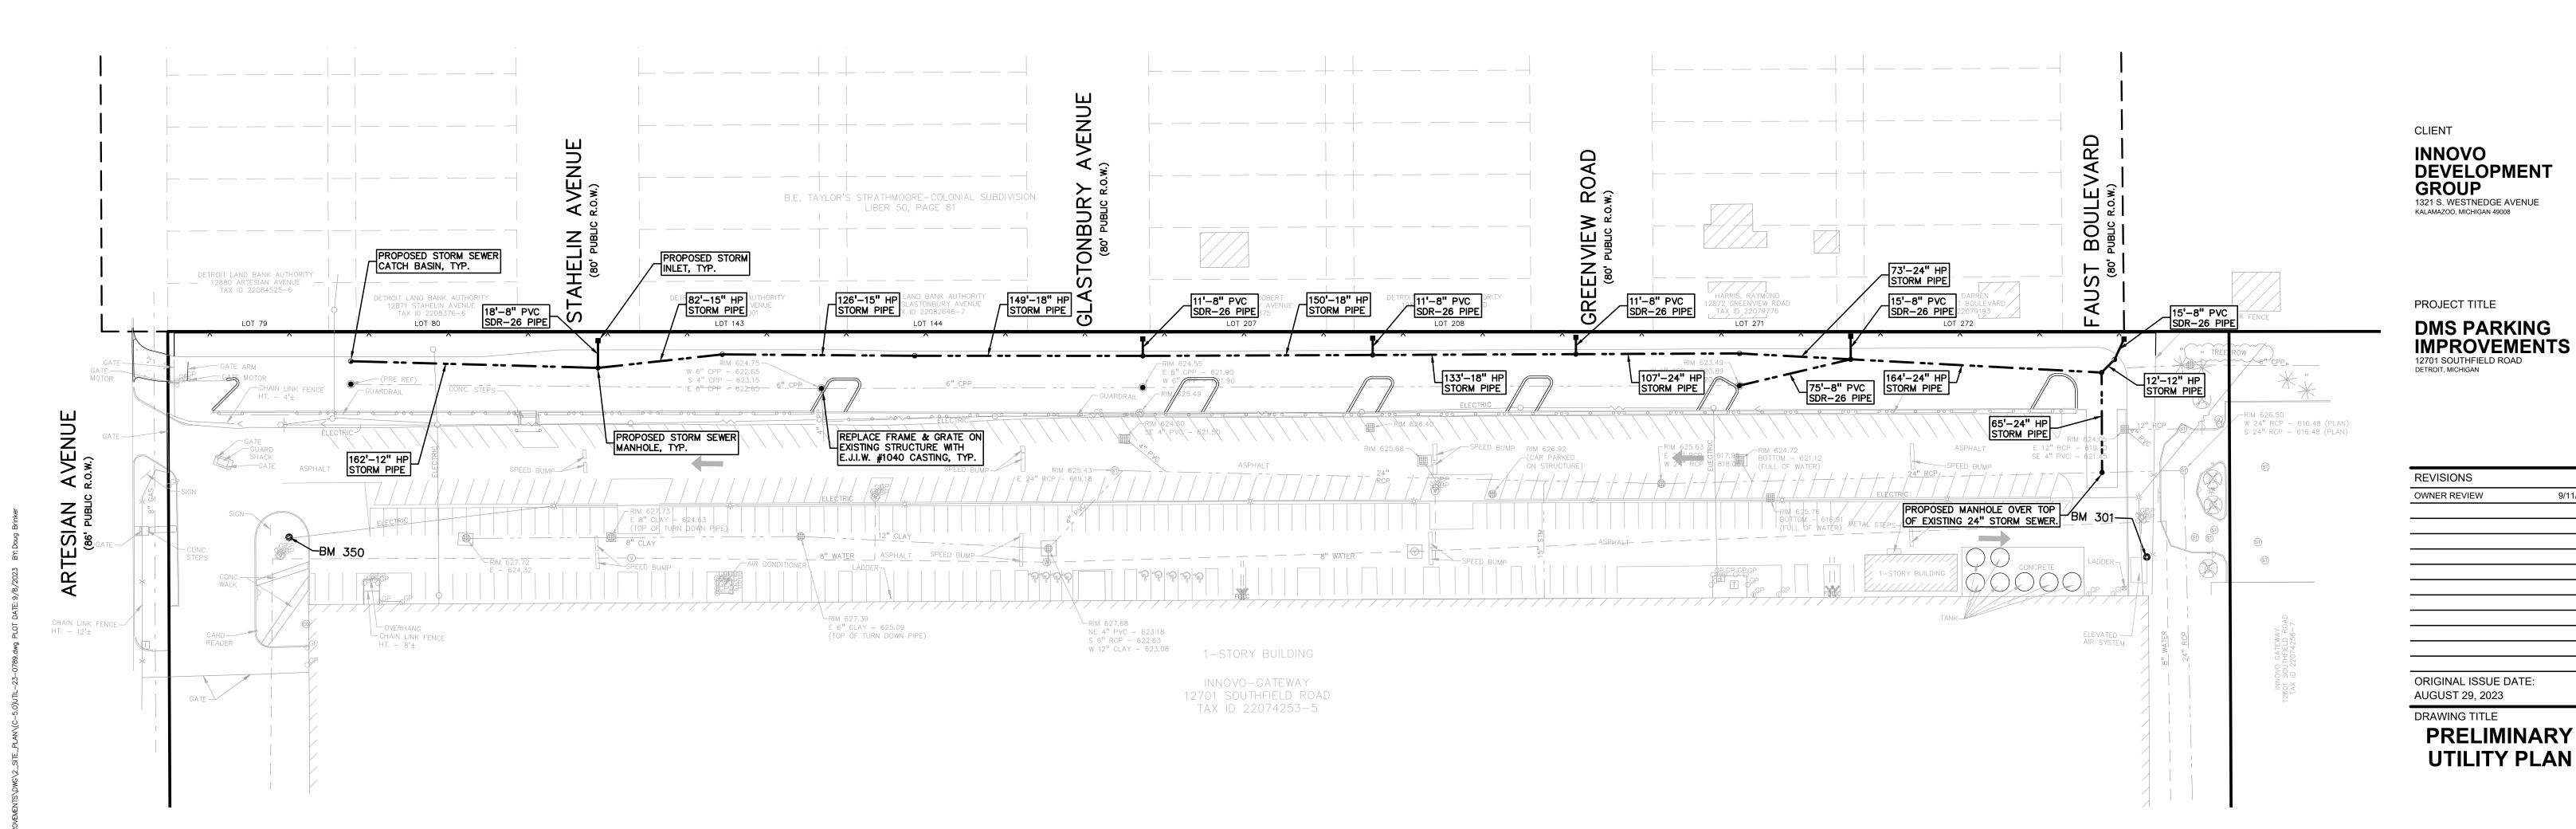


23-0789 PEA JOB NO. MRM DLB DLB DRAWING NUMBER:


GENERAL NOTES:

- THESE NOTES APPLY TO ALL CONSTRUCTION ACTIVITIES ON THIS PROJECT.
- ALL CONSTRUCTION, WORKMANSHIP AND MATERIALS SHALL BE IN ACCORDANCE WITH CURRENT OSHA, MDOT AND MUNICIPALITY STANDARDS AND REGULATIONS.
- THE CONTRACTOR SHALL NOTIFY THE CITY OF DETROIT ENGINEER AND/OR THE AUTHORITY HAVING JURISDICTION 3 BUSINESS DAYS PRIOR TO THE BEGINNING OF CONSTRUCTION.
- 3. THE CONTRACTOR SHALL CONTACT THE ENGINEER SHOULD THEY ENCOUNTER ANY DESIGN ISSUES DURING CONSTRUCTION. IF THE CONTRACTOR MAKES DESIGN MODIFICATIONS WITHOUT THE WRITTEN DIRECTION OF THE DESIGN ENGINEER, THE CONTRACTOR DOES SO
- . ALL NECESSARY PERMITS, TESTING, BONDS AND INSURANCES ETC., SHALL BE PAID FOR BY THE CONTRACTOR. THE OWNER SHALL PAY FOR ALL CITY INSPECTION FEES.
- 5. THE CONTRACTOR SHALL NOTIFY THE APPROPRIATE 811/ONE CALL UTILITY LOCATING CENTER, THE CITY ENGINEER AND/OR THE AUTHORITY HAVING JURISDICTION 3 BUSINESS DAYS PRIOR TO THE BEGINNING OF CONSTRUCTION. IF NO NOTIFICATION IS GIVEN AND DAMAGE RESULTS, SAID DAMAGE WILL BE REPAIRED AT SOLE EXPENSE OF THE CONTRACTOR. IF EXISTING UTILITY LINES ARE ENCOUNTERED THAT CONFLICT IN LOCATION WITH NEW CONSTRUCTION, THE CONTRACTOR SHALL NOTIFY THE DESIGN ENGINEER SO THAT THE CONFLICT MAY BE RESOLVED.
- . CONTRACTOR SHALL VERIFY THAT THE PLANS AND SPECIFICATIONS ARE THE VERY LATEST PLANS AND SPECIFICATIONS AND FURTHERMORE, VERIFY THAT THESE PLANS AND SPECIFICATIONS HAVE BEEN APPROVED. ALL ITEMS CONSTRUCTED BY THE CONTRACTOR PRIOR TO RECEIVING FINAL APPROVAL, HAVING TO BE ADJUSTED OR RE-DONE, SHALL BE AT THE CONTRACTORS EXPENSE. SHOULD THE CONTRACTOR ENCOUNTER A CONFLICT BETWEEN THESE PLANS AND/OR SPECIFICATIONS, THEY SHALL SEEK CLARIFICATION IN WRITING FROM THE ENGINEER BEFORE COMMENCEMENT OF CONSTRUCTION. FAILURE TO DO SO SHALL BE AT SOLE
- ANY WORK WITHIN THE STREET OR HIGHWAY RIGHTS-OF-WAY SHALL BE PERFORMED IN ACCORDANCE WITH THE REQUIREMENTS OF THE AGENCIES HAVING JURISDICTION AND SHALL NOT BEGIN UNTIL ALL NECESSARY PERMITS HAVE BEEN ISSUED FOR THE WORK.
- 3. ALL PROPERTIES OR FACILITIES IN THE SURROUNDING AREAS. PUBLIC OR PRIVATE. DESTROYED OR OTHERWISE DISTURBED DUE TO CONSTRUCTION, SHALL BE REPLACED AND/OR RESTORED TO THE ORIGINAL CONDITION BY THE CONTRACTOR.
- 9. THE CONTRACTOR SHALL PROVIDE ALL NECESSARY BARRICADING, SIGNAGE, LIGHTS AND TRAFFIC CONTROL DEVICES TO PROTECT THE WORK AND SAFELY MAINTAIN TRAFFIC IN ACCORDANCE WITH LOCAL REQUIREMENTS AND THE MANUAL OF UNIFORM TRAFFIC CONTROL DEVICES (LATEST EDITION). THE DESIGN ENGINEER, OWNER, CITY AND STATE SHALL NOT BE HELD LIABLE FOR ANY CLAIMS RESULTING FROM ACCIDENTS OR DAMAGES CAUSED BY THE CONTRACTOR'S FAILURE TO COMPLY WITH TRAFFIC AND PUBLIC SAFETY REGULATIONS DURING THE CONSTRUCTION PERIOD.
- 10. THE USE OF CRUSHED CONCRETE IS PROHIBITED ON THE PROJECT WITHIN 100 FEET OF ANY WATER COURSE (STREAM, RIVER, COUNTY DRAIN, ETC.) AND LAKE, REGARDLESS OF THE APPLICATION OR LOCATION OF THE WATER COURSE OR LAKE RELATIVE TO THE
- 11. IT SHALL BE THE RESPONSIBILITY OF THE CONTRACTOR TO ADJUST THE TOP OF ALL EXISTING AND PROPOSED STRUCTURES (MANHOLES, CATCH BASINS, INLETS, GATE WELLS ETC.) WITHIN GRADED AND /OR PAVED AREAS TO FINAL GRADE SHOWN ON THE PLANS. ALL SUCH ADJUSTMENTS SHALL BE INCIDENTAL TO THE JOB AND WILL NOT BE PAID FOR SEPARATELY.


PAVING NOTES:

- . IN AREAS WHERE NEW PAVEMENTS ARE BEING CONSTRUCTED, THE TOPSOIL AND SOIL CONTAINING ORGANIC MATTER SHALL BE REMOVED PRIOR TO PAVEMENT CONSTRUCTION.
- 2. REFER TO ARCHITECTURAL PLANS FOR DETAILS OF FROST SLAB AT EXTERIOR BUILDING DOORS.
- 3. CONSTRUCTION TRAFFIC SHOULD BE MINIMIZED ON THE NEW PAVEMENT. IF CONSTRUCTION TRAFFIC IS ANTICIPATED ON THE PAVEMENT STRUCTURE, THE INITIAL LIFT THICKNESS COULD BE INCREASED AND PLACEMENT OF THE FINAL LIFT COULD BE DELAYED UNTIL THE MAJORITY OF THE CONSTRUCTION ACTIVITIES HAVE BEEN COMPLETED. THIS ACTION WILL ALLOW REPAIR OF LOCALIZED FAILURE, IF ANY DOES OCCUR, AS WELL AS REDUCE LOAD DAMAGE ON THE PAVEMENT SYSTEM.
- 4. ALL EXPANSION JOINTS AND CONCRETE PAVEMENT JOINTS TO BE SEALED.
- 5. CONCRETE PAVEMENT JOINTING UNLESS SHOWN OTHERWISE IN THE PLANS OR REQUIRED BY THE AUTHORITY HAVING JURISDICTION; 5.1. WHERE PROPOSED CONCRETE ABUTS A STRUCTURE, PROVIDE A MINIMUM 1/2" EXPANSION JOINT. THE JOINT FILLER BOARD MUST
- BE AT LEAST THE FULL DEPTH OF THE CONCRETE AND HELD DOWN A 1/2" TO ALLOW FOR SEALING. 5.2. WHERE PROPOSED CONCRETE ABUTS EXISTING CONCRETE OR IN BETWEEN POURS OF PROPOSED CONCRETE (CONSTRUCTION JOINT), PROVIDE 5/8" DOWELS EVERY 30" CENTER TO CENTER HALF WAY ALONG THE THICKNESS OF THE PROPOSED PAVEMENT.
- ALTERNATE DOWELS SIZES AND SPACING MUST BE APPROVED THE ENGINEER PRIOR TO COMMENCING WORK AND VIA THE SUBMITTAL PROCESS. 5.3. WHERE PROPOSED CONCRETE ABUTS EXISTING OR PROPOSED SIDEWALK OR CURBING, PROVIDE A MINIMUM 1/2" EXPANSION JOINT.
- 5.4. CONTROL, LONGITUDINAL AND/OR TRANSVERSE JOINTS SHALL BE PLACED TO PROVIDE PANELS WITHIN THE PAVEMENT AS SQUARE AS POSSIBLE WITH THE FOLLOWING MAXIMUM SPACING PARAMETERS:
- 5.4.1. 6-INCH THICK CONCRETE PAVEMENT: 12' X 12' 5.4.2. 8-INCH THICK CONCRETE PAVEMENT: 15' X 15'
- 5.5. IRREGULAR-SHAPED PANELS MAY REQUIRE THE USE OF REINFORCING MESH OR FIBER MESH AS DETERMINED BY THE ENGINEER. THE USE OF MESH MUST BE APPROVED THE ENGINEER PRIOR TO COMMENCING WORK AND VIA THE SUBMITTAL PROCESS.
- 5.6. IF A JOINT PLAN IS NOT PROVIDED IN THE PLANS, THE CONTRACTOR SHALL SUBMIT ONE TO THE ENGINEER FOR REVIEW PRIOR TO COMMENCING WORK AND VIA THE SUBMITTAL PROCESS.
- 6. CONCRETE CURBING JOINTING UNLESS SHOWN OTHERWISE IN THE PLANS OR REQUIRED BY THE AUTHORITY HAVING JURISDICTION
- 6.1. JOINTS WHEN ADJACENT TO ASPHALT PAVEMENT 6.1.1. PLACE CONTRACTION JOINTS AT 10' INTERVALS
- 6.1.2. PLACE 1/2" EXPANSION JOINT AT CATCH BASINS, EXISTING AND PROPOSED SIDEWALK OR EXISTING CURBING. 6.1.3. PLACE 1" EXPANSION JOINT:
- 6.1.3.1. AT SPRING POINTS OF INTERSECTIONS OR ONE OF THE END OF RADIUS LOCATIONS IN A CURVE
- 6.1.3.2. AT 400' MAXIMUM INTERVALS ON STRAIGHT RUNS 6.1.3.3. AT THE END OF RADIUS AT OPPOSITE ENDS IN A CURBED LANDSCAPE ISLAND
- 6.2. JOINTS WHEN TIED TO CONCRETE PAVEMENT
- 6.2.1. PLACE CONTRACTION JOINTS OPPOSITE ALL TRANSVERSE CONTRACTION JOINTS IN PAVEMENT
- 6.2.2. PLACE 1/2" EXPANSION JOINT AT CATCH BASINS, EXISTING AND PROPOSED SIDEWALK OR EXISTING CURBING. 6.2.3. PLACE 1"EXPANSION JOINT OPPOSITE ALL TRANSVERSE EXPANSION JOINTS IN PAVEMENT
- 6.2.4. CURB AND GUTTER AND CONCRETE SHALL BE TIED TOGETHER SIMILAR TO A LONGITUDINAL LANE TIE JOINT (MDOT B1 JOINT) 6.3. IN BETWEEN POURS OF PROPOSED CONCRETE CURBING (CONSTRUCTION JOINT):
- 6.3.1. CARRY THE REBAR CONTINUOUSLY BETWEEN POURS 6.3.2. IF THE REBAR IS NOT LONG ENOUGH TO CARRY CONTINUOUSLY, THEN TIE TWO PIECES OF REBAR PER THE LATEST MOOT
- SPECIFICATIONS
- . CONCRETE SIDEWALK JOINTING UNLESS SHOWN OTHERWISE IN THE PLANS OR REQUIRED BY THE AUTHORITY HAVING JURISDICTION 7.1. PLACE TRANSVERSE CONTRACTION JOINTS EQUAL TO THE WIDTH OF THE WALK WHEN WIDTH IS LESS THAN 8' 7.2. PLACE TRANSVERSE AND LONGITUDINAL CONTRACTION JOINTS EQUAL TO 1/2 THE WIDTH OF THE WALK WHEN WIDTH IS EQUAL TO
- OR GREATER THAN 8' 7.3. PLACE 1" EXPANSION JOINT WHERE ABUTTING SIDEWALK RAMP AND/OR RADIUS IN INTERSECTION
- 7.4. PLACE TRANSVERSE 1/2" EXPANSION JOINT AT MAXIMUM OF 100' SPACING 7.5. PLACE 1/2" EXPANSION JOINT WHEN ABUTTING A FIXED STRUCTURE, OTHER PAVEMENT (CONCRETE PAVEMENT AND DRIVE APPROACHES), UTILITY STRUCTURES, LIGHT POLE BASES AND COLUMNS

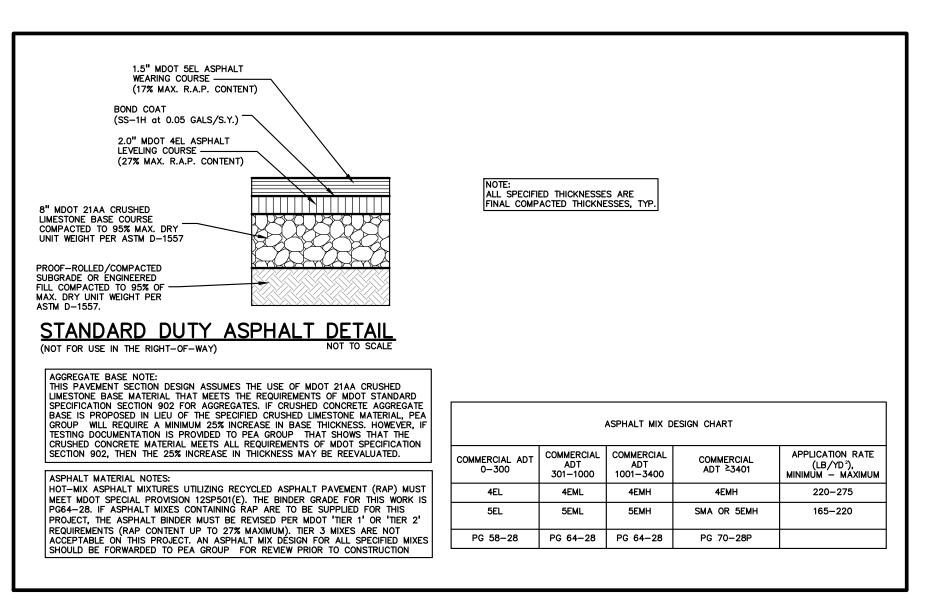


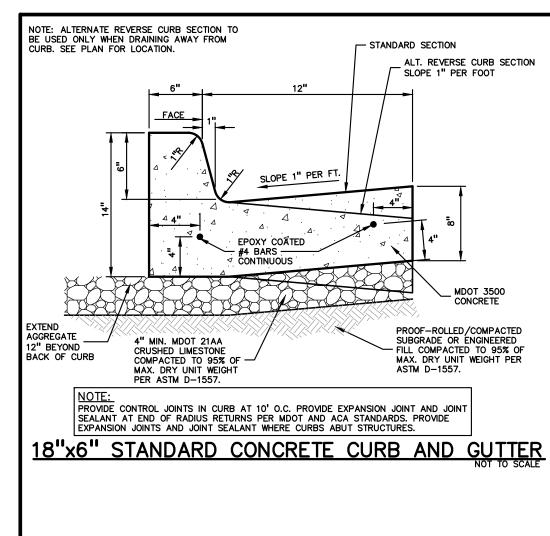



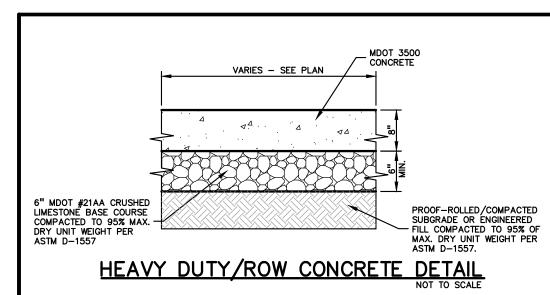



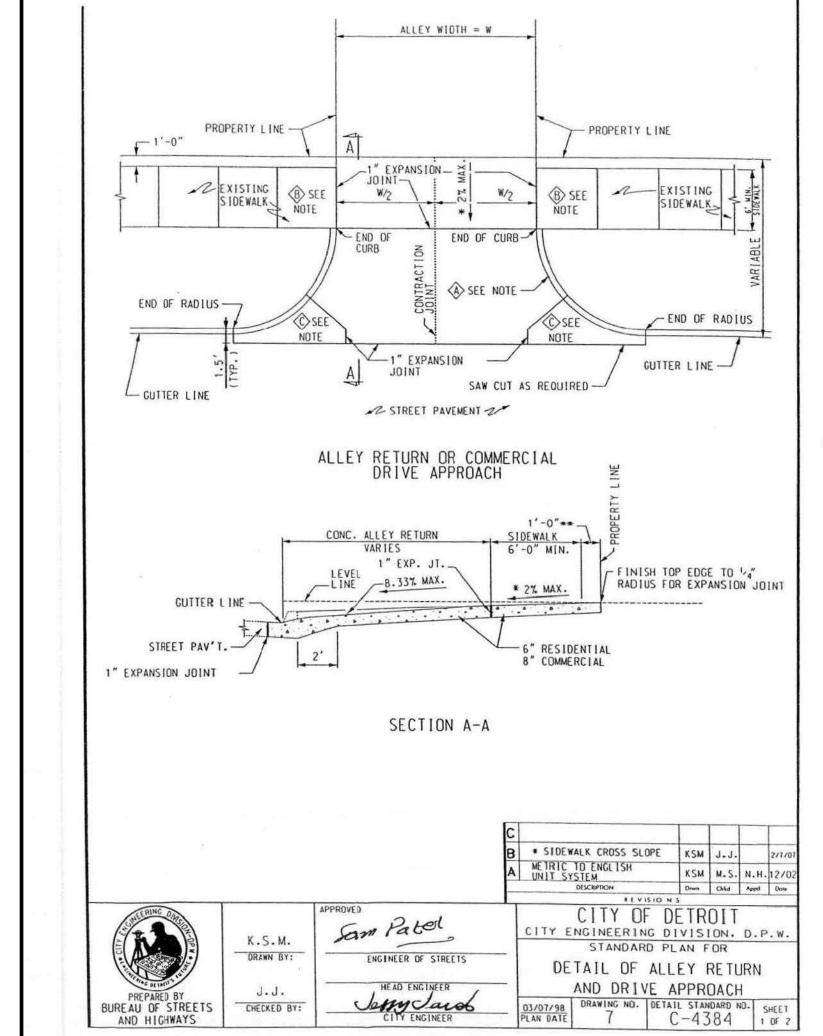



PROJECT TITLE

REVISIONS OWNER REVIEW

DMS PARKING **IMPROVEMENTS** 12701 SOUTHFIELD ROAD

ORIGINAL ISSUE DATE:
AUGUST 29, 2023
DRAWING TITLE
NOTES AND

DETAILS

9/11/23

PEA JOB NO.	23-0789
P.M.	MRM
DN.	DLB
DES.	DLB
DRAWING NUMBER:	

NOT FOR CONSTRUCTION

GENERAL PLANTING NOTES:

- LANDSCAPE CONTRACTOR SHALL VISIT SITE, INSPECT EXISTING SITE CONDITIONS AND REVIEW PROPOSED PLANTING AND RELATED WORK. IN CASE OF DISCREPANCY BETWEEN PLAN AND PLANT LIST, PLAN SHALL GOVERN QUANTITIES. CONTACT LANDSCAPE ARCHITECT WITH ANY CONCERNS.
- 2. CONTRACTOR SHALL VERIFY LOCATIONS OF ALL ON SITE UTILITIES PRIOR TO BEGINNING CONSTRUCTION ON HIS/HER PHASE OF WORK. ELECTRIC, GAS, TELEPHONE, CABLE TELEVISION MAY BE LOCATED BY CALLING MISS DIG 1-800-482-7171. ANY DAMAGE OR INTERRUPTION OF SERVICES SHALL BE THE RESPONSIBILITY OF CONTRACTOR. CONTRACTOR SHALL COORDINATE ALL RELATED ACTIVITIES WITH OTHER TRADES ON THE JOB AND SHALL REPORT ANY UNACCEPTABLE JOB CONDITIONS TO OWNER'S REPRESENTATIVE PRIOR TO
- 3. ALL PLANT MATERIAL TO BE PREMIUM GRADE NURSERY STOCK AND SHALL SATISFY AMERICAN ASSOCIATION OF NURSERYMEN STANDARD FOR NURSERY STOCK. ALL LANDSCAPE MATERIAL SHALL BE NORTHERN GROWN, NO. 1. GRADE.
- 4. CONTRACTOR IS RESPONSIBLE FOR VERIFYING ALL QUANTITIES SHOWN ON LANDSCAPE PLAN PRIOR TO PRICING THE WORK.
- 5. THE OWNER'S REPRESENTATIVE RESERVES THE RIGHT TO REJECT ANY PLANT MATERIAL NOT MEETING SPECIFICATIONS.
- 6. ALL SINGLE STEM SHADE TREES TO HAVE STRAIGHT TRUNKS AND SYMMETRICAL CROWNS.
- 7. ALL SINGLE TRUNK SHADE TREES TO HAVE A CENTRAL LEADER; TREES WITH FORKED OR IRREGULAR TRUNKS WILL NOT BE ACCEPTED.
- 8. ALL MULTI STEM TREES SHALL BE HEAVILY BRANCHED AND HAVE SYMMETRICAL CROWNS. ONE SIDED TREES OR THOSE WITH THIN OR OPEN CROWNS SHALL NOT BE ACCEPTED.
- 9. ALL EVERGREEN TREES SHALL BE HEAVILY BRANCHED AND FULL TO THE GROUND, SYMMETRICAL IN SHAPE AND NOT SHEARED FOR THE LAST FIVE GROWING SEASONS.
- 10.ALL TREES TO HAVE CLAY OR CLAY LOAM BALLS, TREES WITH SAND BALLS WILL BE REJECTED.
- 11.NO MACHINERY IS TO BE USED WITHIN THE DRIP LINE OF EXISTING TREES; HAND GRADE ALL LAWN AREAS WITHIN THE DRIP LINE OF EXISTING TREES.
- 12.ALL TREE LOCATIONS SHALL BE STAKED BY LANDSCAPE CONTRACTOR AND ARE SUBJECT TO THE APPROVAL OF THE LANDSCAPE ARCHITECT PRIOR TO INSTALLATION OF THE PLANT
- 13.IT IS MANDATORY THAT POSITIVE DRAINAGE IS PROVIDED AWAY FROM ALL BUILDINGS.
- 14.ALL PLANTING BEDS SHALL RECEIVE 3" SHREDDED HARDWOOD BARK MULCH WITH PRE EMERGENT, SEE SPECIFICATIONS. SHREDDED PALETTE AND DYED MULCH WILL NOT BE
- 15.ALL LANDSCAPED AREAS SHALL RECEIVE 3" COMPACTED TOPSOIL.

ARTE

- 16.SEE SPECIFICATIONS FOR ADDITIONAL COMMENTS, REQUIREMENTS, PLANTING PROCEDURES AND WARRANTY STANDARDS.
- 17.CONTRACTOR SHALL NOT TO INSTALL PLANTS UNDER BUILDING OVERHANG AND SHALL NOTIFY LANDSCAPE ARCHITECT IF DRAWINGS CONFLICT WITH BUILDING OVERHANGS.

SPACING PER PLAN

2.5" CAL. B&B

2.5" CAL. B&B

2.5" CAL. B&B

8` HT.

8` HT.

B&B

B&B

REMARKS

<u>REMARKS</u>

 \bigcirc

= DECIDUOUS TREES

= EVERGREEN BUFFER TREES

= IRRIGATED SEEDED LAWN

= NON-IRRIGATED SEED LAWN

= SHRUBS

LETTER DESIGNATION FOR ORDINANCE REQUIRED MATERIAL

- P = PARKING LOT TREES
- R = R.O.W. TREES

SEE L-2.0 FOR LANDSCAPE DETAILS

www.peagroup.com

LANDSCAPE CALCULATIONS: PER CITY OF DETROIT ZONING ORDINANCE

RIGHT OF WAY TREES

REQUIRED: 1 TREE / 30 LF OF R.O.W. 35/30 = 1 TREES PROVIDED: 1 PROPOSED TREE

PARKING LOT SCREENING

REQUIRED: 30"-36" HT. SCREENING HEDGE MIN. 5' FOR PERSONAL PARKING PROVIDED: 7 EVG SHRUBS

PARKING LOT LANDSCAPE


REQUIRED: 22 SF LANDSCAPE AREA PER SPACE (7' IN ANY DIRECTION & 150 SF MIN.) 98 NEW SPACES * 22 SF = 2,156 / 250 = 9 TREES PROVIDED: 2,551 SF OF INTERIOR LANDSCAPE AREA AND 9



SCALE: 1" = 50'



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PLANT SCHEDULE L-1.0

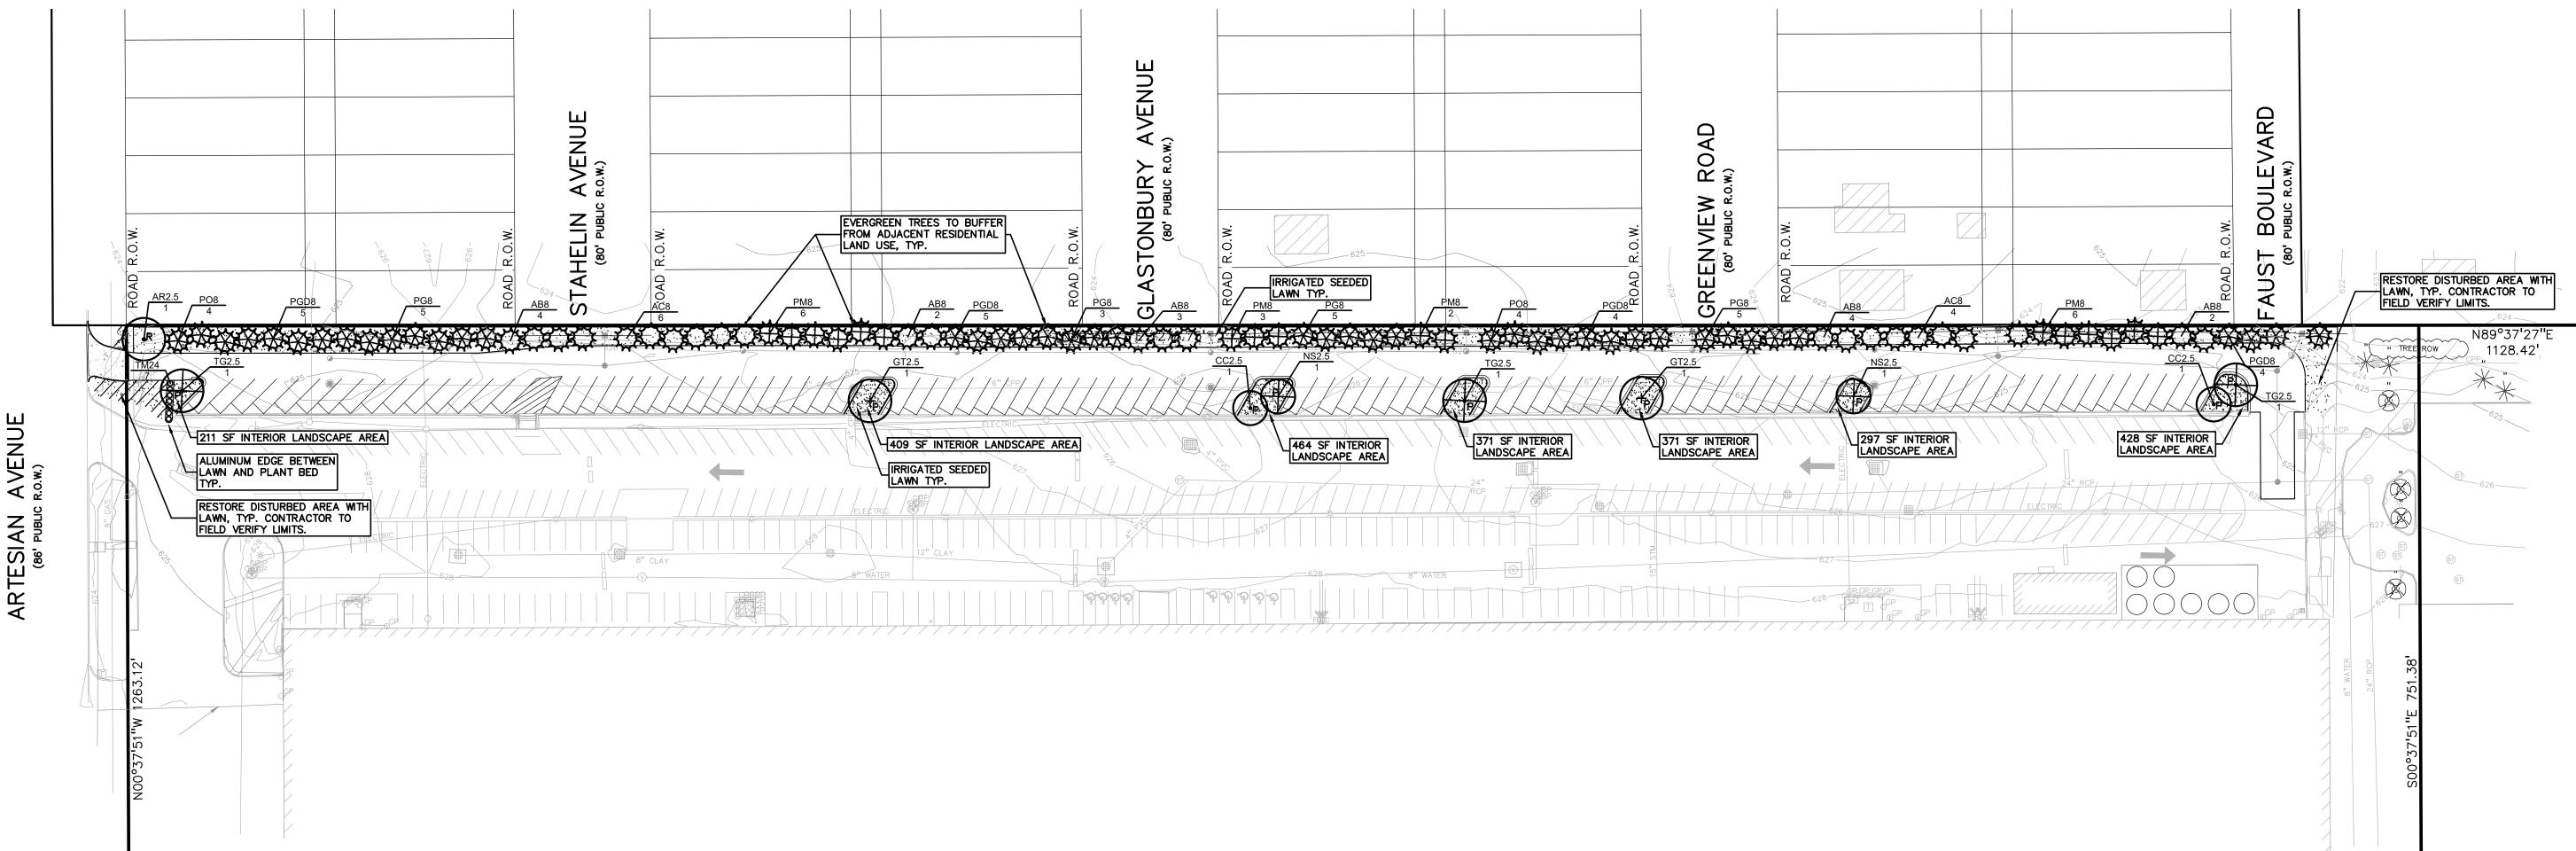BOTANICAL / COMMON NAME ACER RUBRUM 'RED SUNSET' / RED SUNSET MAPLE

TILIA CORDATA 'GREENSPIRE' / GREENSPIRE LITTLELEAF LINDEN

BOTANICAL / COMMON NAME TAXUS X MEDIA 'DENSIFORMIS' / DENSE ANGLO-JAPANESE YEW

GLEDITSIA TRIACANTHOS INERMIS 'SKYCOLE' / SKYLINE® HONEY LOCUST 2.5" CAL. B&B

CERCIS CANADENSIS / EASTERN REDBUD

NYSSA SYLVATICA / TUPELO

ABIES CONCOLOR / WHITE FIR

PICEA GLAUCA / WHITE SPRUCE

PICEA OMORIKA / SERBIAN SPRUCE

PSEUDOTSUGA MENZIESII / DOUGLAS FIR

PICEA GLAUCA 'DENSATA' / BLACK HILLS SPRUCE

DECIDUOUS TREES
AR2.5

EVERGREEN TREES

CC2.5

GT2.5

NS2.5

TG2.5

PG8

PGD8

PO8

SHRUBS TM24


CLIENT **INNOVO DEVELOPMENT GROUP** 1321 S. WESTNEDGE AVENUE KALAMAZOO, MICHIGAN 49008 PROJECT TITLE DMS PARKING **IMPROVEMENTS** 12701 SOUTHFIELD ROAD DETROIT, MICHIGAN REVISIONS OWNER REVIEW ORIGINAL ISSUE DATE: AUGUST 29, 2023 DRAWING TITLE

PEA JOB NO. 23-0789 MRM DES. DRAWING NUMBER:


LANDSCAPE

PLAN



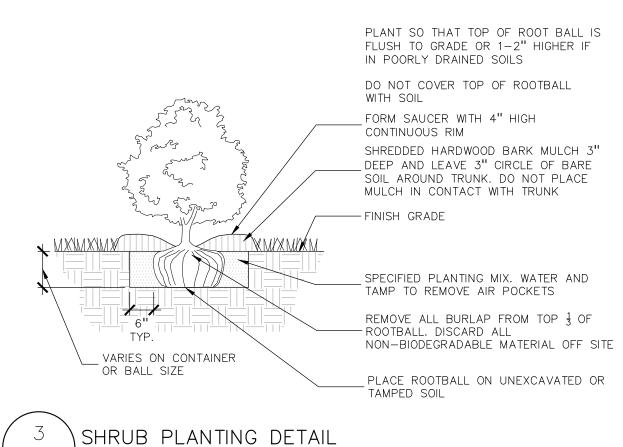

SCALE: 1'' = 2'-0''

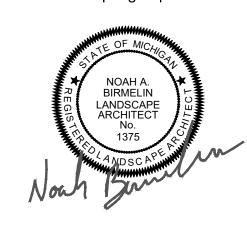



CAUTION!! THE LOCATIONS!

THE LOCATIONS AND ELEVATIONS OF EXISTING UNDERGROUND UTILITIES AS SHOWN ON THIS DRAWING ARE ONLY APPROXIMATE. NO GUARANTEE IS EITHER EXPRESSED OR IMPLIED AS TO THE COMPLETENESS OR ACCURACY THEREOF. THE CONTRACTOR SHALL BE EXCLUSIVELY RESPONSIBLE FOR DETERMINING THE EXACT UTILITY LOCATIONS AND ELEVATIONS PRIOR TO THE START OF CONSTRUCTION.

PLANT SO THAT THE TREE'S ROOT FLARE (TRUNK FLARE) IS FLUSH WITH GRADE OR 1-2" HIGHER IN POORLY DRAIN SOIL. STAKE JUST BELOW BRANCHES WITH 2"-3" WIDE NYLON OR PLASTIC STRAPS. CONNECT FROM TREE TO STAKE AND ALLOW FOR FLEXIBILITY. REMOVE AFTER (1) ONE YEAR. (DO NOT USE WIRE & HOSE) THREE 2"X2" HARDWOOD STAKES OR STEEL T-POSTS DRIVEN A MIN. OF 18" DEEP FIRMLY INTO SUBGRADE PRIOR TO BACKFILLING SHREDDED HARDWOOD BARK MULCH TO DRIPLINE. 3" DEEP AND LEAVE 3" CIRCLE OF CLIENT BARE SOIL AROUND TREE TRUNK. DO NOT PLACE MULCH IN CONTACT WITH TREE TRUNK. FORM SAUCER WITH 4" HIGH CONTINUOUS RIM - FINISH GRADE SPECIFIED PLANTING MIX, WATER & TAMP TO REMOVE AIR POCKETS, AMEND SOIL PER SITE CONDITIONS & TREE REQUIREMENTS EXPOSE ROOT FLARE OF TREE. CONTRACTOR MAY HAVE TO REMOVE EXCESS SOIL FROM - TOP OF ROOTBALL. REMOVE ALL BURLAP FROM TOP $\frac{1}{3}$ OF ROOTBALL. DISCARD ALL MIN. TYP.

INNOVO **DEVELOPMENT** GROUP 1321 S. WESTNEDGE AVENUE KALAMAZOO, MICHIGAN 49008

NON-BIODEGRADABLE MATERIAL OFF SITE PROJECT TITLE

PLACE ROOTBALL ON UNEXCAVATED OR

DMS PARKING IMPROVEMENTS 12701 SOUTHFIELD ROAD

9/11/23


REVISIONS

OWNER REVIEW

ORIGINAL ISSUE DATE:

AUGUST 29, 2023

DRAWING TITLE

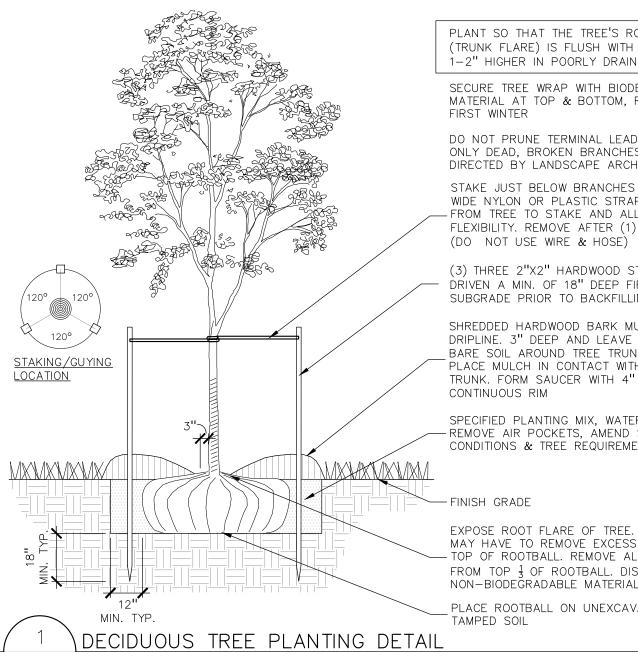

EVERGREEN TREE PLANTING DETAIL

SCALE: 1'' = 3'-0''

SCALE: 1'' = 3'-0''

PERMALOC ALUMINUM EDGING OR APPROVED

EQUAL WITH BLACK FINISH

- COMPACTED SUBGRADE

LANDSCAPE BED EDGING SHALL BE ALUMINUM AS MANUFACTURED BY

8' OR 16' SECTIONS SHALL BE USED WITH ONE STAKE PER 38" OF

EDGING SHALL BE $\frac{3}{16}$ " THICK X 4" DEPTH WHEN ADJ. TO MULCH AND

THICK X 5 ½" DEPTH WHEN ADJ. TO ROCK, FINISH: BLACK DURAFLEX MEETING AAMA 2603

STAKE SHALL SECURELY ENGAGE EDGING AND SHALL BE ENTIRELY BELOW TOP SURFACE OF EDGING

EDGING SHALL HAVE A MINIMUM OF 2" OF INTERLOCKING OVERLAP

INSTALL AS PER MANUFACTURER'S SPECIFICATIONS WITH TOP OF

EDGING $\frac{1}{4}$ " - $\frac{1}{2}$ " ABOVE COMPACTED FINISH GRADE. FINISH GRADE TO

BE COMPACTED ON BOTH SIDES OF EDGING TO MAINTAIN STABILITY

-BED MEDIA

SPECIFICATIONS FOR LANDSCAPE BED EDGING:

PERMALOC 1.800.356.9660

BETWEEN SECTIONS

PLANT SO THAT THE TREE'S ROOT FLARE (TRUNK FLARE) IS FLUSH WITH GRADE OR 1-2" HIGHER IN POORLY DRAIN SOIL.

SECURE TREE WRAP WITH BIODEGRADABLE MATERIAL AT TOP & BOTTOM, REMOVE AFTER DO NOT PRUNE TERMINAL LEADER PRUNE

ONLY DEAD, BROKEN BRANCHES AS DIRECTED BY LANDSCAPE ARCHITECT STAKE JUST BELOW BRANCHES WITH 2"-3" WIDE NYLON OR PLASTIC STRAPS. CONNECT - FROM TREE TO STAKE AND ALLOW FOR FLEXIBILITY. REMOVE AFTER (1) ONE YEAR.

(3) THREE 2"X2" HARDWOOD STAKES DRIVEN A MIN. OF 18" DEEP FIRMLY INTO SUBGRADE PRIOR TO BACKFILLING

SHREDDED HARDWOOD BARK MULCH TO DRIPLINE. 3" DEEP AND LEAVE 3" CIRCLE OF BARE SOIL AROUND TREE TRUNK. DO NOT PLACE MULCH IN CONTACT WITH TREE TRUNK. FORM SAUCER WITH 4" HIGH CONTINUOUS RIM

SPECIFIED PLANTING MIX, WATER & TAMP TO - REMOVE AIR POCKETS, AMEND SOIL PER SITE CONDITIONS & TREE REQUIREMENTS

- FINISH GRADE

EXPOSE ROOT FLARE OF TREE. CONTRACTOR MAY HAVE TO REMOVE EXCESS SOIL FROM TOP OF ROOTBALL. REMOVE ALL BURLAP FROM TOP $\frac{1}{3}$ OF ROOTBALL. DISCARD ALL NON-BIODEGRADABLE MATERIAL OFF SITE _ PLACE ROOTBALL ON UNEXCAVATED OR TAMPED SOIL

PEA JOB NO. 23-0789 MRM P.M. DN.

LANDSCAPE

DETAILS

SCALE: 1/2'' = 1'-0''

ALUMINUM EDGE DETAIL

NOT FOR CONSTRUCTION

DRAWING NUMBER: